
SELLWOOD / 30TH AVE. / MADISON SAFE PROJECT

CIP2018-T41

CITY OF MILWAUKIE ENGINEERING DEPARTMENT 6101 SE JOHNSON CREEK BLVD MILWAUKIE, OR 97206

PHONE (503) 786-7600 (503) 774-8236



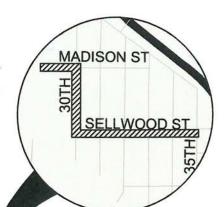

PROJECT MAP

THIS PROJECT WILL CONSIST OF FILLING IN SIDEWALK GAPS AND REPLACING PORTIONS OF EXISTING SIDEWALK ALONG MADISON STREET, PORTIONS OF 20TH AVENUE, AND SELLWOOD STREET. ALSO, THE PROJECT A IMS TO UPGRADE 25 EXISTING CURB RAMPS ALONG SELLWOOD AND MADISON STREETS. UPGRADING THE CURB RAMPS WILL INCLUDE CONCRETE CURB REMOVAL AND REPLACEMENT, CONCRETE SIDEWALK REMOVAL AND REPLACEMENT, INSTALLATION OF ADA-COMPLIANT TACTILE WARNING PAD, AND OTHER INCIDENTAL WORK REQUIRED TO COMPLETE THE WORK

PROJECT	MANAGE
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Jennifer Garbely, PE Assistant City Engineer 503-786-7534 Phone Number GarbelyJ@milwaukieoregon.go

Todd Jones

PROJECT DESIGN LEAD

PHONE NUMBER: 503-786-7548 EMAIL ADDRESS: PrenticeT@milwau

MILWAUKIE OPERATIONS

Emergency On-Cal

PORTLAND GENERAL ELECTRIC

Phone Number (Ernergency): 503-464-7777 503-736-5404 Phone Number (Service): 503-523-7131

NORTHWEST NATURA

Nina Carlson 503-226-4211 CENTURY LINE

Contact Name:

503-242-4144 Cell Number: 503-754-7289

Chad Vaughn 503-813-0484 Contact Name Phone Number:

ABBREVIATIONS

AMERICANS WITH DISABILITIES ACT

BEST MANAGEMENT PRACTICE

OREGON DEPARTMENT OF ENVIRONMENTAL QUALITY

EROSION AND SEDIMENT CONTROL

F/C BES OSD FACE OF CURB BUREAU OF ENVIRONMENTALSERVICES

OREGON STANDARD DRAWING

OREGON STANDARD SPECIFICATIONS FOR CONSTRUCTION

OREGON STANDARD DRAWING ROADWAY SECTION

STORMWATER

OREGON STANDARD DRAWING TRAFFIC SECTION

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CV02	NOTES SHEET			
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SHEET 3 OF 6	Survey — By others			
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SHEET 6 OF 6	SURVEY - BY OTHERS			
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DP05	DEMOLITION PLAN — SELLWOOD STREET			
DP06	DEMOLITION PLAN — SELLWOOD STREET			
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CP02	CONSTRUCTION PLAN — 30TH AVENUE			
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DTO4	CONSTRUCTION DETAILS			
DTD5	CONSTRUCTION DETAILS			

Oregon law requires contractors to follow rules adopted by the Oregon Utility Notification Center. Those rules are set forth in OAR 952—001—0010 through 952—001—0090. Contractors may obtain copies of the rules by calling the Oregon Utility Notification Center at 503—232—1987.



Know what's below. Call before you dig.

\Box					7 VI 20 VI
					6/12/2018 DATE
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\neg				TP	9/12/2018 DATE
\neg				DRAFTED	
\neg				JG	10/3/2018 DATE
\neg				CHECKED	DATE
\neg				CE	10/1/2018 DATE
\neg				APPROVED	DATE
<u>_ </u>	DATE	BY	REVISIONS		





6101 SE JOHNSON CREEK BLVD. MILWAUKIE, OR 97206

503-774-8236

Sellwood / 30th Ave / Madison SAFE Project

COVER SHEET

PROJECT NO.: CIP2018-T41

CONTRACT NO .:

9/24/2018

SHEET NO .:

CV01

CITY OF **MILWAUKIE**

GENERAL REQUIREMENTS NOTES

- 1. THE LOCATION AND DESCRIPTION OF UTILITIES SHOWN ARE COMPILED FROM AVAILABLE RECORDS AND FIELD SURVEYS. THE CITY AND UTILITY COMPANIES DO NOT GUARANTEE THE ACCURACY NOR THE COMPLETENESS OF SUCH RECORDS
- 2. THE CONTRACTOR SHALL TAKE NO ADVANTAGE OF ANY ERRORS, OMISSIONS, OR DISCREPANCIES IN THE PLANS. WHEN ERRORS, OMISSIONS, OR DISCREPANCIES ARE FOUND, PROJECT DESIGNER SHALL BE NOTIFIED. WORK PERFORMED BY THE CONTRACTOR AS A RESULT OF THE ERROR, OMISSION, OR DISCREPANCY IN THE PLANS SHALL BE AT THE CONTRACTOR'S RISK AND EXPENSE WHEN SUCH ERROR, OMISSION, OR DISCREPANCY HAS NOT BEEN BROUGHT TO THE ATTENTION OF THE PROJECT DESIGNER.
- 3. THE CONTRACTOR SHALL HAVE AT ALL TIMES ON-SITE, THE APPROVED CONSTRUCTION PLANS & SPECIAL SPECIFICATIONS, CITY OF MILWAUKIE STANDARD SPECIFICATIONS & STANDARD PLANS, AND ALL OTHER APPLICABLE SPECIFICATIONS BOOKS AND MANUALS.
- 4. CONTRACTOR SHALL COMPLY WITH THE CURRENT EDITION OF THE OREGON STANDARD SPECIFICATIONS FOR CONSTRUCTION, IN ITS ENTIRETY.
- 5. THE CONTRACTOR SHALL REMOVE ALL MATERIALS EXCAVATED FROM WORK IN THE RIGHT-OF-WAY AND DISPOSE AT A PROPER LANDFILL.
- 6. THE CONTRACTOR SHALL SCHEDULE A PRE-CONSTRUCTION MEETING WITH THE CITY OF MILWAUKIE ENGINEERING DEPARTMENT PRIOR TO THE START OF WORK. THE CONTRACTOR SHALL PROVIDE TWO (2) WEEKS NOTICE TO SCHEDULE A PRE-CONSTRUCTION MEETING.
- 7. CONTRACTOR SHALL CALL OREGON E-PERMITTING INSPECTION LINE AT 1-(888) 299-2821 AT LEAST 24-HOURS IN ADVANCE TO SCHEDULE INSPECTION FOR THE FOLLOWING WORK:

 PUBLIC UTILITY EXCAVATION

 STORM FACILITY STRUCTURES — INSTALLATION AND FORMS

 - ·STORM FACILITY BACKFILL
 - STORM FACILITY PLANTINGS
 PUBLIC UTILITY INSTALLATION
 PUBIC UTILITY CONNECTIONS
 STREET SUB-GRADE

 - STREET BASE AGGREGATE
 STREET PAVEMENT INSTALLATION
 CURB & SIDEWALK FORMS

 - FINAL INSPECTION • PUBLIC UTILITY TESTING
- 8. ANY LANDSCAPING/TREES DAMAGED OR DESTROYED DURING CONSTRUCTION SHALL BE REPAIRED OR REPLACED IN CONFORMANCE WITH THE CITY OF MILWAUKIE STANDARDS.
- 9. CONTRACTOR SHALL NOT USE THE PUBLIC RIGHT OF WAY FOR STORAGE OF EQUIPMENT, MATERIALS, CONSTRUCTION TRAILERS, AND CONSTRUCTION VEHICLES UNLESS OTHERWISE APPROVED.
- 10. IT IS THE OBLIGATION OF THE CONTRACTOR TO OBTAIN WRITTEN APPROVAL FROM PRIVATE PROPERTY OWNERS FOR USE OF PRIVATE PROPERTY FOR CONSTRUCTION STAGING AND TO RESTORE PRIVATE PROPERTY TO A CONDITION SATISFACTORY TO PROPERTY OWNER UPON COMPLETION OF THE PROJECT. THE CONTRACTOR SHALL PROVIDE A COPY OF ALL AGREEMENTS SIGNED WITH PRIVATE PROPERTY OWNERS.
- 11. PRIOR TO FINAL ACCEPTANCE AND FINAL PAYMENT, CONTRACTOR SHALL SUBMIT AN APPROVED SET OF "AS CONSTRUCTED" DRAWINGS TO THE CITY OF MILWAUKIE ENGINEERING DEPARTMENT SHOWING ANY CHANGES FROM THE ORIGINAL PLAN. THE CONTRACTOR SHALL KEEP A COMPLETE SET OF "AS BUILTS" ON SITE THAT MUST BE KEPT UP TO DATE AT ALL TIMES
- 12. CONTRACTOR SHALL INSTALL, UTILIZE, AND MAINTAIN EROSION PREVENTION AND SEDIMENT CONTROL DEVICES IN ACCORDANCE WITH THE EROSION PREVENTION & SEDIMENT CONTROL NOTES AND DETAILS.

- 1. CONTRACTOR SHALL COMPLY WITH ALL REQUIREMENTS ADOPTED BY THE OREGON UTILITY NOTIFICATION CENTER. THESE REQUIREMENTS ARE SET FORTH IN OAR 952-001-0010 THROUGH 952-001-0100. NOTIFICATION TO THE CENTER SHALL OCCUR AT LEAST TWO (2) BUSINESS DAYS AND NOT MORE THAN TEN (10) BUSINESS DAYS PRIOR TO AN
- 2. UTILITY LOCATIONS SHALL BE VERIFIED BY OREGON UTILITIES NOTIFICATION CENTER IMMEDIATELY PRIOR TO ANY EXCAVATION. CONTRACTOR SHALL BE RESPONSIBLE FOR MAINTAINING UTILITY LOCATE MARKINGS FOR THE DURATION OF THE PROJECT. AND SHALL BE RESPONSIBLE FOR LOCATING NEW UTILITIES PRIOR TO CITY ACCEPTANCE.
- 3. PROVISIONS SHALL BE MADE BY THE CONTRACTOR TO KEEP ALL EXISTING UTILITIES IN SERVICE AND PROTECT THEM DURING CONSTRUCTION. THE UTILITY OWNER SHALL BE NOTIFIED IN THE EVENT OF DAMAGE. REPAIRS WILL BE MADE AT THE CONTRACTOR'S EXPENSE.
- 4. FOR ANY EXISTING UNDERGROUND UTILITY CONFLICTING WITH THE PROPOSED WORK DESCRIBED HEREIN, CONTRACTOR SHALL NOTIFY CITY STAFF OF THE CONFLICTS.
- 5. UTILITIES SHOWN ON THESE PLANS ARE FOR INFORMATION AND COORDINATION PURPOSES ONLY AND ARE NOT AUTHORIZED FOR INSTALLATION UNDER THE PUBLIC STREET IMPROVEMENT PERMIT, UTILITY COMPANIES ARE REQUIRED TO SECURE SEPARATE UTILITY PERMITS FROM THE CITY FOR ANY WORK WITHIN THE PUBLIC RIGHT-OF-WAY.
- 6. UTILITIES OR INTERFERING PORTIONS OF UTILITIES THAT ARE ABANDONED IN PLACE SHALL BE REMOVED BY THE CONTRACTOR TO THE EXTENT NECESSARY TO ACCOMPLISH THE WORK. ABANDONED UTILITIES SHALL BE VERIFIED BY CITY STAFF PRIOR TO REMOVAL. THE CONTRACTOR SHALL PLUG THE REMAINING EXPOSED ENDS OF ABANDONED UTILITIES WITH CONCRETE A MINIMUM OF TWO (2) FEET INTO THE PIPE.
- 7. ALL UTILITY CROSSINGS SHALL BE POTHOLED BY CONTRACTOR PRIOR TO EXCAVATION TO ALLOW FOR GRADE ADJUSTMENTS DUE TO ALIGNMENT CONFLICTS. THE USE OF BENDS TO AVOID ALIGNMENT CONFLICTS WILL NOT BE ALLOWED UNLESS
- 8. EXISTING UTILITY SERVICES SHALL BE MAINTAINED AT ALL TIMES. WHEN SERVICE DISRUPTIONS ARE REQUIRED, CONTRACTOR SHALL NOTIFY AFFECTED BUSINESS OR RESIDENCE OF THE DATE AND DURATION OF THE DISRUPTION. 48 HOURS IN ADVANCE OF THE DISRUPTION.
- 9. ALL UTILITY POINTS OF CONNECTION TO THE EXISTING SYSTEM SHALL BE POTHOLED PRIOR TO THE START OF NEW UTILITY INSTALLATION TO VERIFY ALIGNMENT, DEPTH, PIPE SIZE, AND PIPE MATERIAL. THE CONTRACTOR SHALL ARRANGE A PRE CONNECTION MEETING WITH THE CITY PRIOR TO THE START OF CONNECTION WORK.

STREET PAVEMENT NOTES

- 1. THE CONTRACTOR SHALL ADJUST ALL VALVE BOXES, MANHOLES AND WATER METERS TO FINISHED STREET, DRIVEWAY, OR SIDEWALK GRADE.
- 2. THE CONTRACTOR SHALL SAWCUT STRAIGHT MATCHLINES TO CREATE A BUTT JOINT BETWEEN THE EXISTING PAVEMENT AND NEW PAVEMENT. SEAL ALL NEW PAVEMENT JOINTS WITH RUBBERIZED SEALANT.
- 3. ASPHALT CONCRETE SHALL BE COMPACTED TO OSSC STANDARDS.

PERMANENT SIGNAGE, MARKINKG AND STRIPING NOTES

- 1. CONTRACTOR SHALL NOT REMOVE ANY STREET SIGNAGE WITHOUT PRIOR CITY APPROVAL.
- 2. CONTRACTOR SHALL REPLACE DAMAGED SIGNS OR SIGN POLES.
- 3. CONTRACTOR SHALL REPLACE DAMAGED OR REMOVED PAVEMENT MARKINGS UPON COMPLETION OF FINAL PAVING.
- 4. CONTRACTOR SHALL REPLACE ANY WOODEN OR ROUND METAL SIGN POST IN THE PROJECT BOUNDARY WITH PERFORATED STEEL SQUARE TUBE (PSST) PER DETAIL OSD TM 681. POLES MOUNTED IN GROUND SHALL USE SLEEVES PER DETAIL

CURB / SIDEWALK / DRIVEWAY NOTES

- 1. THE CONTRACTOR TO CONSTRUCT CURB, SIDEWALK, AND DRIVEWAYS IN ACCORDANCE WITH APPROVED OREGON STANDARD
- 2. CONTRACTOR TO PROTECT NEW CONCRETE FINISH. CONTRACTOR RESPONSIBLE FOR REMOVING, REPLACING, AND DISPOSING OF MATERIAL IF FINISH DOES NOT MEET ENGINEERING STANDARDS.

				TP	6/12/2018
				DESIGNED	DATE
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				JG	10/3/2018
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				APPROVED	DATE
NO.	DATE	BY	REVISIONS		





6101 SE JOHNSON CREEK BLVD.

MILWAUKIE. OR 97206

PHONE: 503-786-7600 FAX: 503-774-8236 Sellwood / 30th Ave / Madison SAFE Project NOTES SHEET

PROJECT NO.: CIP2018-T41

CONTRACT NO.: DATE:

9/24/2018

SHEET NO .:

CV02

VICINITY MAP

LEGEND

= FOUND MONUMENT AS NOTED

TREES

= DECIDUOUS TREE

} = EVERGREEN TREE

= ASPHALT SURFACE

= CONCRETE SURFACE

= GRAVEL SUFACE

= BLOCK RETAINING WALL

EUROPAINATE = ROCK RETAINING WALL

= CONCRETE RETAINING WALL

1) CONTOURS ARE AT 1' INTERVALS AND ARE COMPUTER GENERATED

2) ALL MANHOLES WERE LOCATED AT CENTERLINE OF RIM.

3) UTILITIES SHOWN ON THE SURVEY HEREON WERE BASED

UPON GROUND/VISUAL OBSERVATIONS OR AS MARKED ONLY. THERE MAY BE UTILITIES ON THE SITE THAT WERE NOT VISIBLE THEREFORE, THEY ARE NOT SHOWN. THE ACTUAL LOCATION OF THE UNDERGROUND UTILITIES MAY VARY.

4) DISTANCES IN THIS SURVEY ARE GROUND MEASURED

5) UTILITY LOCATES ARE PER TICKET NO. 18004827 AND 18004828

6) THIS IS NOT A BOUNDARY SURVEY. FOUND MONUMENTS HAVE NOT BEEN EVALUATED. LOCATION IS SHOWN IN MONUMENT TABLE.

7) PARCEL LINES AND DATA PER CLACKAMS COUNTY GIS

VERTICAL DATUM

NORTH AMERICAN VERTICAL DATUM OF 88

SURFACES

TREES MEASURED AT BREAST HEIGHT(DBH)

♥ = FIRE HYDRANT

↓ = GUY ANCHOR

■ GAS VALVE

- PROJECT SCALE POINT

(D) = STORM DRAIN MANHOLE

S = SANITARY SEWER MANHOLE

- = SIGN AS NOTED

A = SWLS SURVEY CONTROL POINT

W = WATER METER

M = WATER VALVE

T = TELEPHONE JUNCTION BOX

(E) = POWER METER

C = CABLE JUNCTION BOX YARD DRAIN

- = MAJOR CONTOUR LINE

____ = MINOR CONTOUR LINE

= CHAINLINK FENCE

____ . ___ . _ _ . = RIGHT OF WAY-SURVEYED

---- G ---- G --- = UNDERGROUND GAS LINE

— E — = UNDERGROUND POWER

------ ss ------ ss ----- = UNDERGROUND SEWER LINE

T = UNDERGROUND WATER LINE --- OL --- OL --- = OVER-HEAD LINES

---- W ---- = UNDERGROUND WATER LINE

FL = FLOW LINE OF CURB I.E. = INVERT ELEVATION

TC = TOP OF CURB

HORIZONTAL DATUM

NAD 83/2011 EPOCH 2010.0000 OREGON STATE PLANE NORTH ZONE 3601 WITH UNITS INTERNATIONAL FEET (DISTANCES SHOWN IN GROUND)

SCALE FACTOR AND POSITION

AN AVERAGE POSITION FROM SURVEYED MEASUREMENTS WAS CALCULATED FOR THE TWO TOPOGRAPHIC SURVEY AREAS. POINT "AVERAGE" WAS HELD FOR THE GRID TO GROUND CONVERSION.

AVERAGE N: 660248.213' E: 7657028.725' EL: 158.333' N: 45'27'28.87382" W: 122'37'28.29401'

SHEET INDEX

SHEET 1 = INDEX, MONUMENTS, AND SURVEY CONTROL


SHEET 2 = TOPOGRAPHY OF MADISON STREET AND 30TH AVENUE

SHEET 3 = TOPOGRAPHY OF SE 30TH AVENUE

SHEET 3 = TOPOGRAPHY OF SE 39TH AVENUE AND SELLWOOD STREET

SHEET 3 = TOPOGRAPHY OF SELLWOOD STREET


SHEET 3 = TOPOGRAPHY OF SELLWOOD STREET AND 35TH AVENUE

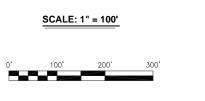

CONDITIONS SURVEY

CITY OF MILWAUKIE OVER A PORTION OF SE ROSWELL STREET, SE 36TH AVENUE, SE WAKE STREET, AND **SE 39TH AVENUE**

SITUATED IN THE NORTHEAST QUARTER OF SECTION 25, TOWNSHIP 1 SOUTH, RANGE 1 EAST OF THE WILLAMETTE MERIDIAN, CITY OF MILWAUKIE, COUNTY OF CLACKAMAS, STATE OF OREGON.

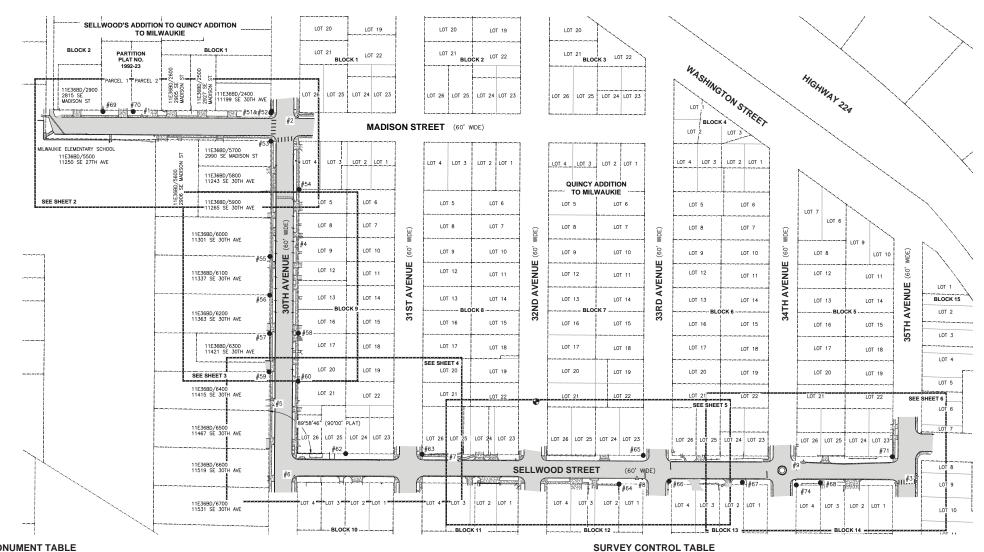

MONUMENT TABLE

POINT NO.	NORTHING	EASTING	DESCRIPTION	ORIGIN
#51	654469.53	7654939.91	5/8" I.R.	SN 29287
#52	654469.39	7654939.82	1/2" I.P.	SN 29287, HELD
#53	654410.03	7654939.87	1/2" I.P.	SN 1345, EAST 0.40'
#54	654309.66	7654998.52	1/2" I.P.	SN 1345, WEST 0.34'
#55	654170.13	7654938.02	3/4" I.P.	UNKNOWN ORIGIN, HELD
#56	654089.60	7654937.37	1/2" I.P.	SN 29287, WEST 0.16'
#57	654009.79	7654937.06	1/2" I.P.	PP 2009-029, HELD
#58	654010.11	7654996.97	1/2" I.R.	SN 2449, HELD
#59	653929.89	7654936.20	1/2" I.R.	PP 2009-029, EAST 0.36'
#60	653910.14	7654996.68	1/2" I.R.	SN 1230, EAST 0.23'
#62	653759.44	7655095.78	5/8" I.R.	SN 2016-057, HELD
#63	653758.29	7655254.76	3/4" I.P.	SN 11716, SOUTH 0.25'

POINT NO.	NORTHING	EASTING	DESCRIPTION	ORIGIN
#64	653696.03	7655665.10	3/4" I.P.	UNKNOWN ORIGIN, HELD
#65	653755.71	7655715.56	3/4" I.P.	UNKNOWN ORIGIN, SOUTH 0.21'
#66	653702.11	7655769.60	3/4" I.P.	UNKNOWN ORIGIN, NORTH 6.50'
#67	653699.67	7655922.04	3/4" I.P.	UNKNOWN ORIGIN, NORTH 4.92'
#68	653698.65	7656084.63	3/4" I.P.	UNKNOWN ORIGIN, NORTH 4.83'
#69	654471.84	7654590.16	1" I.P.	SN 29287
#70	654471.94	7654653.04	5/8" I.R.	SN 29287
#71	653752.96	7656234.51	1" I.P.	SN 9234, HELD
#74	653694.25	7656034.27	1/2" I.R.	SN 1082, NORTH 0.14'

RIGHT	OF	WAY	NAR	RATIVE	Ξ.

S.E. 30TH STREET RIGHT-OF-WAY WAS DEFINED BY HOLDING THE 1/2" I.P. (#52) AT THE NORTHWEST CORNER OF THE INTERSECTION OF SAID S.E. 30TH STREET AND S.E. MADISON STREET AND THE 3/4" I.P. (#57) AT THE NORTHEAST CORNER OF PARCEL 1 OF PARTITION PLAT NO. 2009-029 AS SHOWN ON PARTITION MAP, THEN OFF-SETTING SAID LINE TO THE EAST AT A DISTANCE OF 60 TO ESTABLISH THE THE EAST RIGHT-OF-WAY LINE OF SAID S.E. 30TH STREET.

S.E. SELLWOOD STREET WAS DEFINED BY HOLDING THE 5/8" I.R. (#62) AT THE SOUTHEAST CORNER OF LOT 25, BLOCK 9, PLAT OF "QUINCY ADDITION TO MILWAUKIE" AND THE 1" I.P. AT THE SOUTHEAST CORNER OF LOT 23, BLOCK 5, OF SAID PLAT, THEN OFF-SETTING SAID LINE TO THE SOUTH AT A DISTANCE OF 60" TO ESTABLISH THE THE SOUTH RIGHT-OF-WAY LINE OF SAID SELLWOOD STREET AS SHOWN.

			<u> </u>
I	POINT NO	NORTHING	FASTING
П	PUINT NO.	NORTHING	EASTING

POINT NO.	NORTHING	EASTING	ELEVATION	DESCRIPTION
#1	654462.00	7654670.92	111.39	MAG NAIL
#2	654459.45	7654995.17	100.42	MAG NAIL
#3	653713.91	7656284.87	102.41	MAG NAIL
#4	654192.14	7654993.43	117.01	MAG NAIL
#5	653872.80	7654942.59	132.29	MAG NAIL
#6	653709.81	7654989.00	133.10	MAG NAIL
#7	653746.26	7655334.06	139.06	MAG NAIL
#8	653708.06	7655702.18	127.72	MAG NAIL
#9	653741.84	7656049.30	105.16	MAG NAIL

PROFESSIONAL LAND SURVEYOR Greg Dependent EXPIRES: 06/30/18


SHEET 1 OF 6





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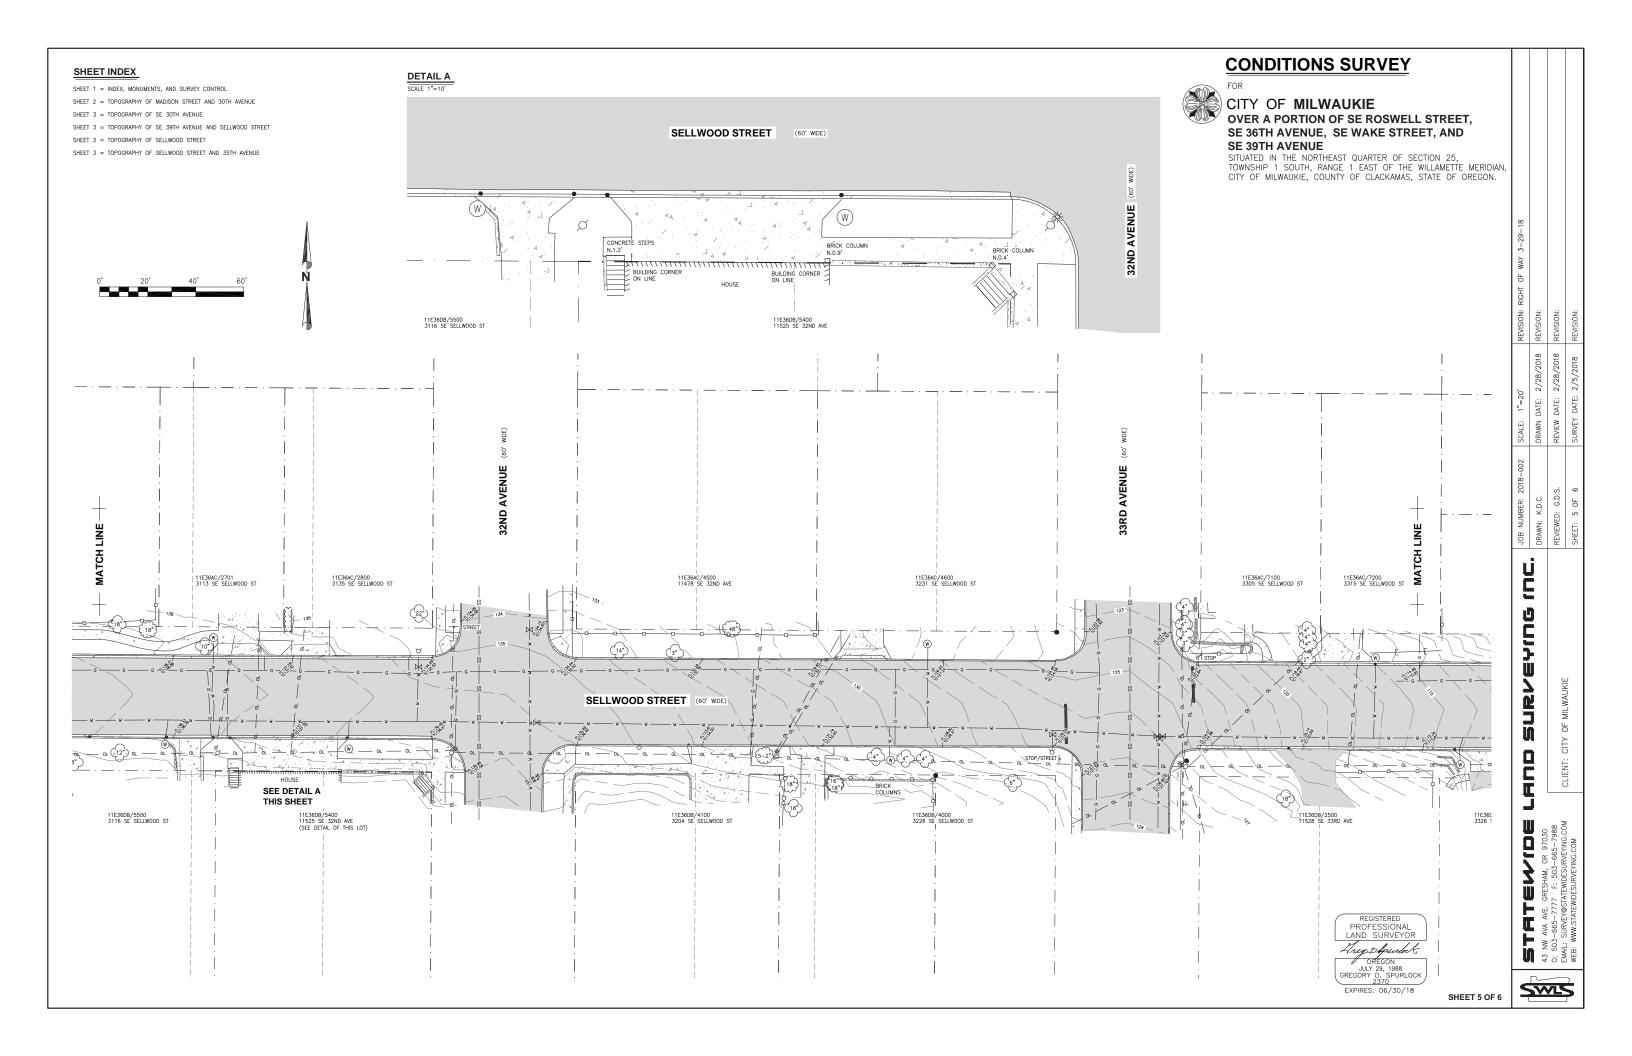
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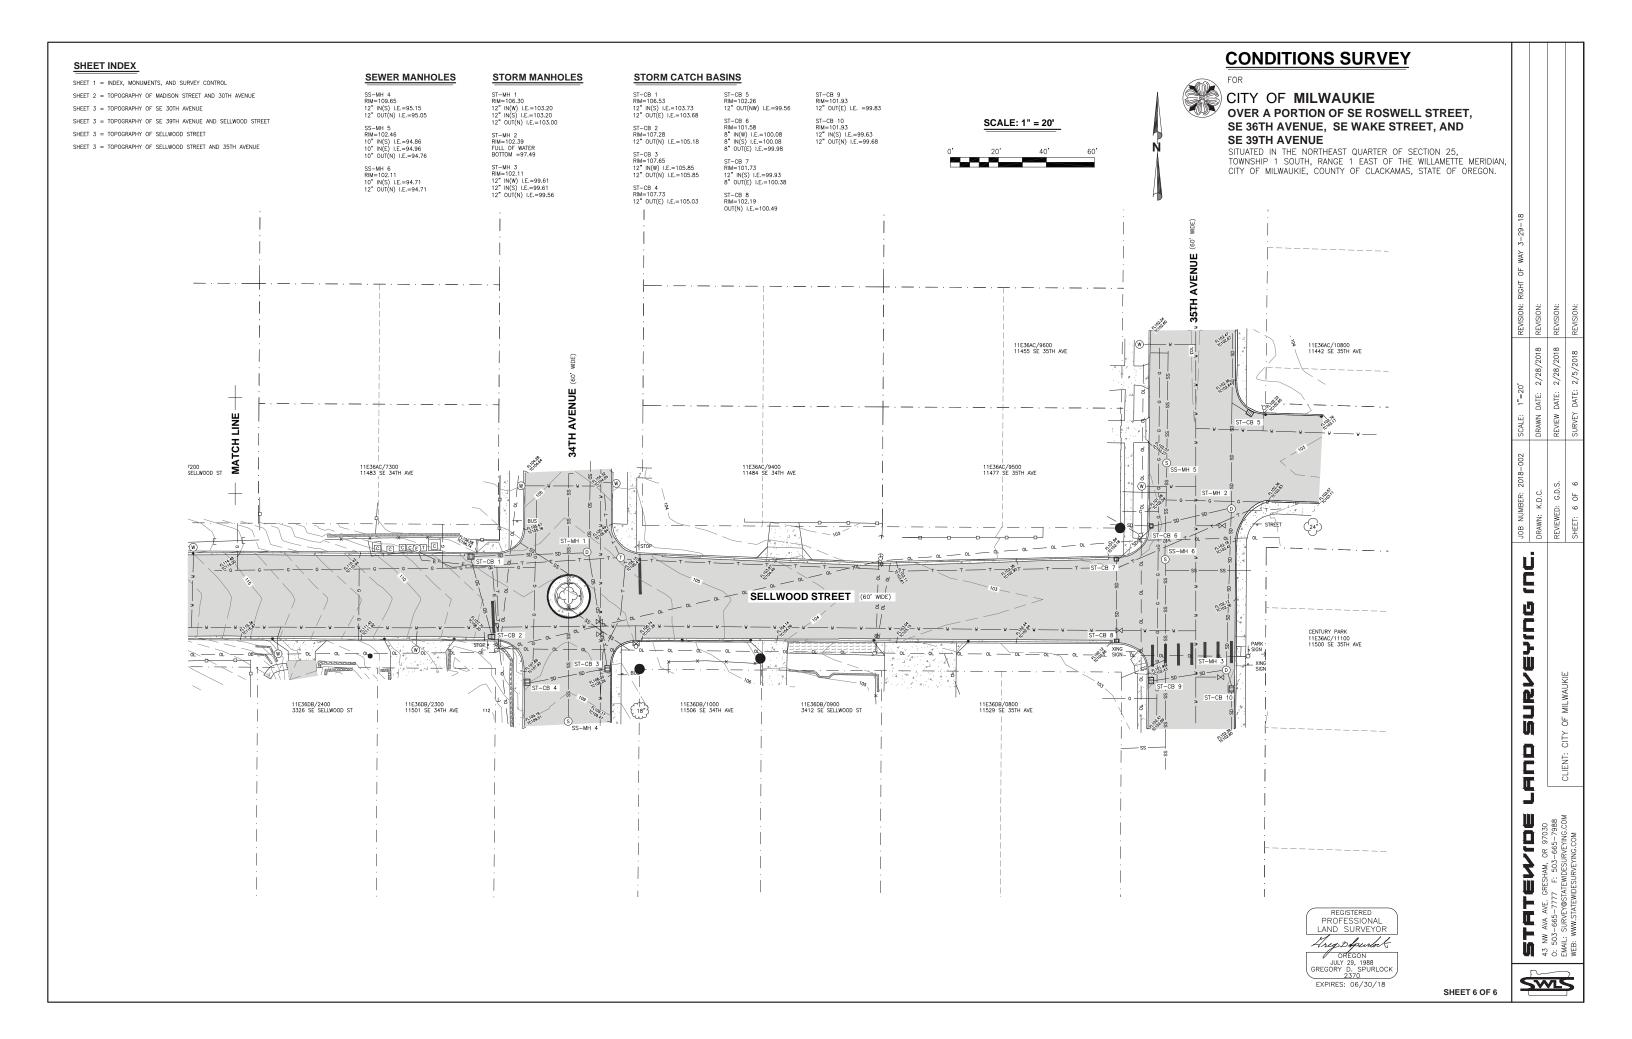
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M4-9b 30x24 sunt on B(II)L) DETOUR M4-9b 30x24 (Mount on B(III DETOUR M4-9b 30x24 DETOUR DETOUR SIDEWALK CLOSED AHEAD CROSS HERE M4-9b 30x24 lount on B(II)F) SIDEWALK DIVERSION DETOUR See inset "A" for Temp. Sidewalk Ramp details. AHEAD CROSS HERE "W" = 60", or, where 60" width cannot b DETOUR M4-9b 30x24 (Mount on B(III Use temporary ADA compliant s to cross planter strips or other non-traversable surfaces. SIDEWALK CLOSURE, MIDBLOCK INSET "C" SIDEWALK CLOSURE, CORNER GENERAL NOTES FOR ALL DETAILS: When closing or relocating crosswalks or other pedestrian facilities provide ADA compilant facilities. Include accessibility features consistent with existing pedestrian facilities by providing adequate slope transitions and surfacing. UNDER PEDESTRIAN TRAFFIC UNDER CONSTRUCTION M4-9b 30x24 unt on Tt OREGON STANDARD DRAWINGS The selection and use of this PEDESTRIAN CHANNELIZATION DEVICE Standard Drawing, while designe TEMPORARY PEDESTRIAN ACCESS ROUTING in accordance with generally To be accompanied by Drg. Nos. TM820 & TM821 accepted engineering principles and practices, is the sole respon-sibility of the user and should not Stage work, as necessary, to provide a temporary pedestrian access route at all times. For roadways with no available detournaintain one open sidewalk at all times. be used without consulting a Registered Professional Engineer ADDITIONAL RIGHT OF WAY SIDEWALK DIVERSION

OSD TM 844 scale: NTS

				TP	6/12/2018 DATE
				DESIGNED	DATE
				TP	9/12/2018
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				JG	10/3/2018
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NO.	DATE	BY	REVISIONS		

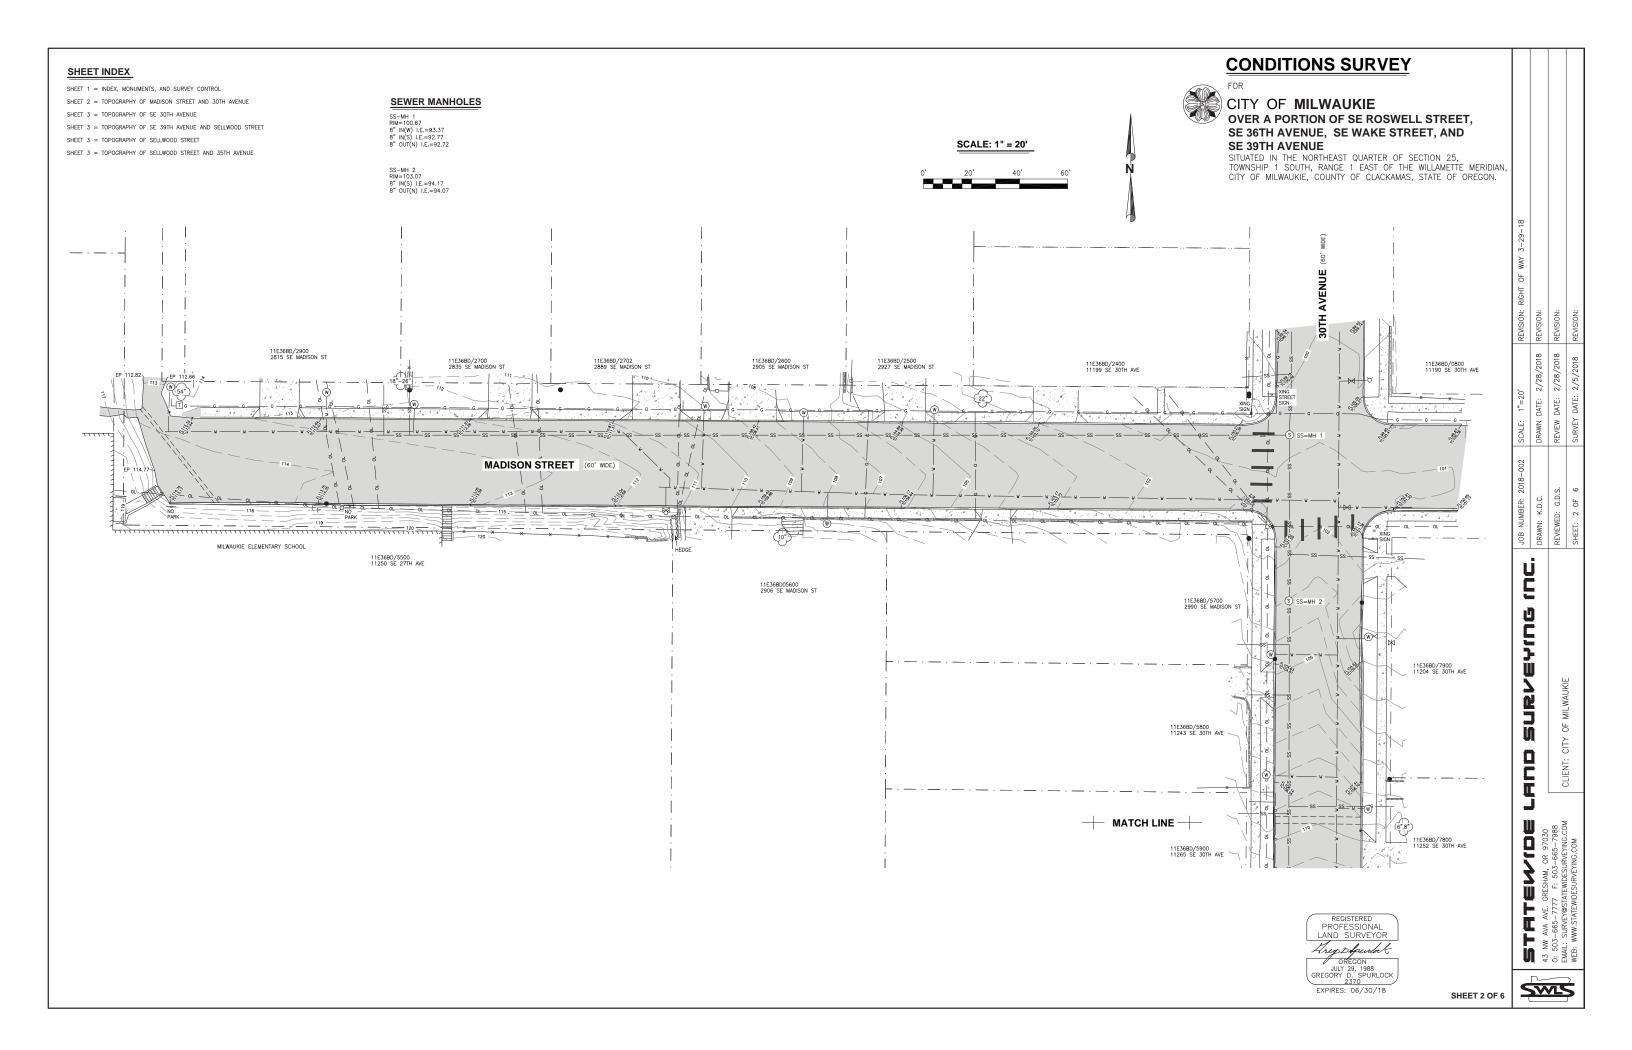

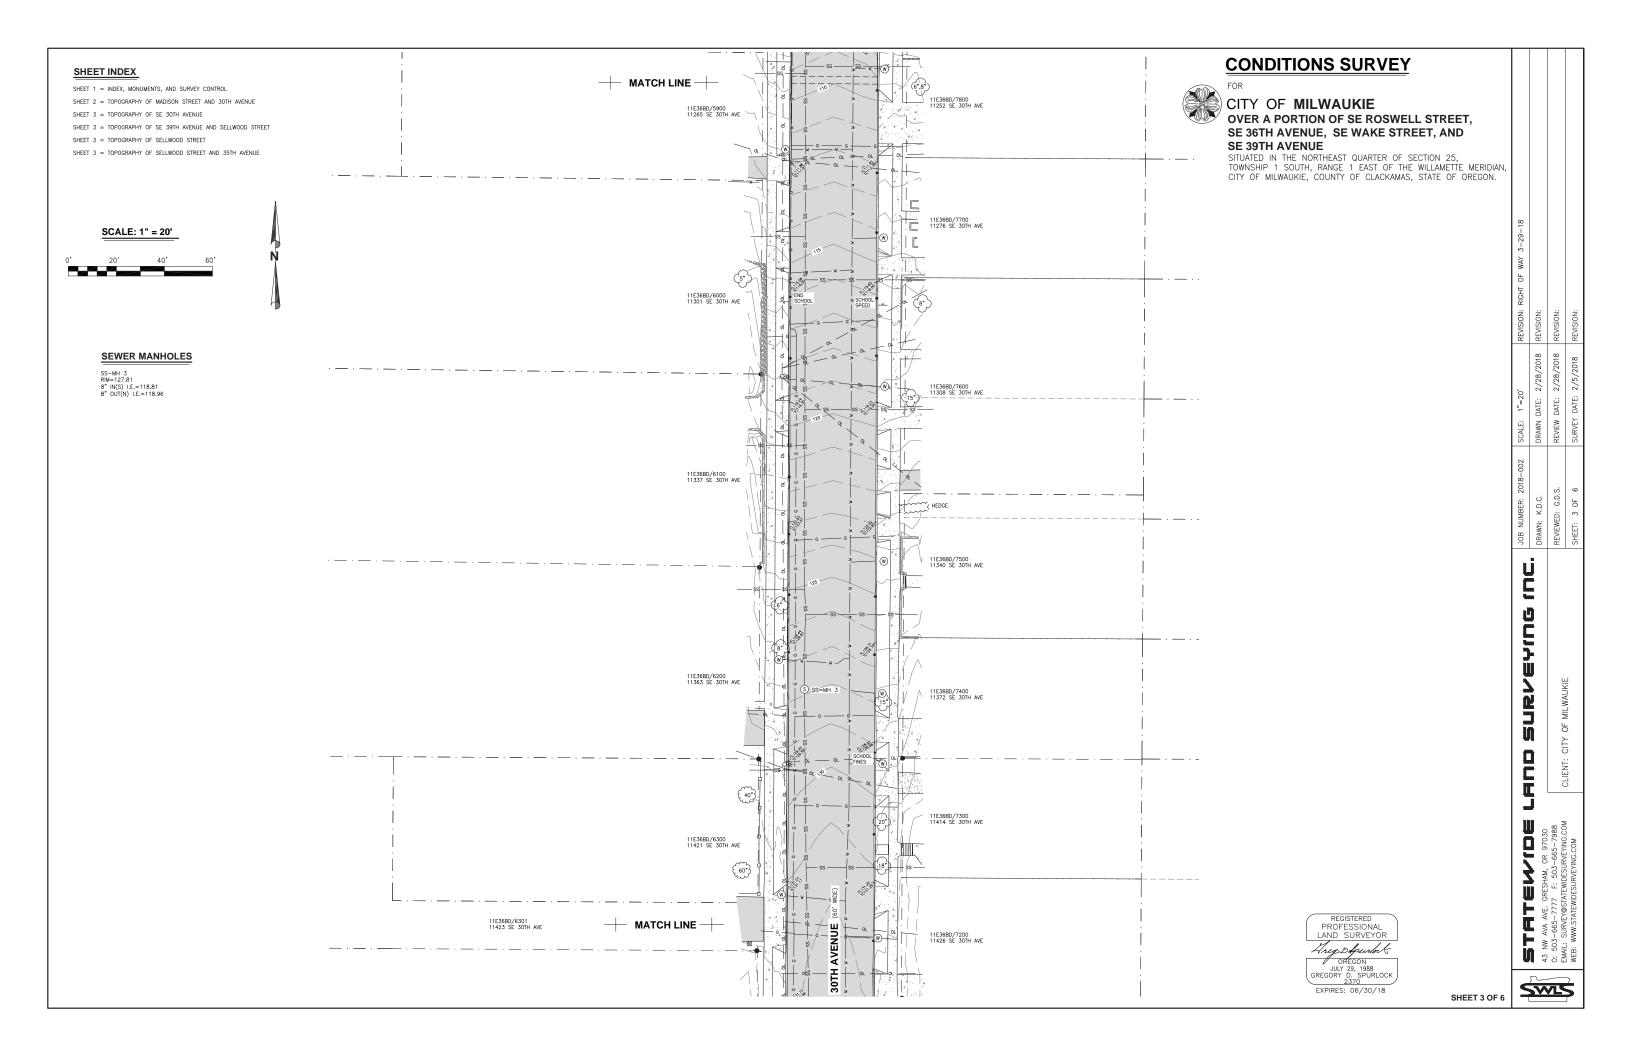

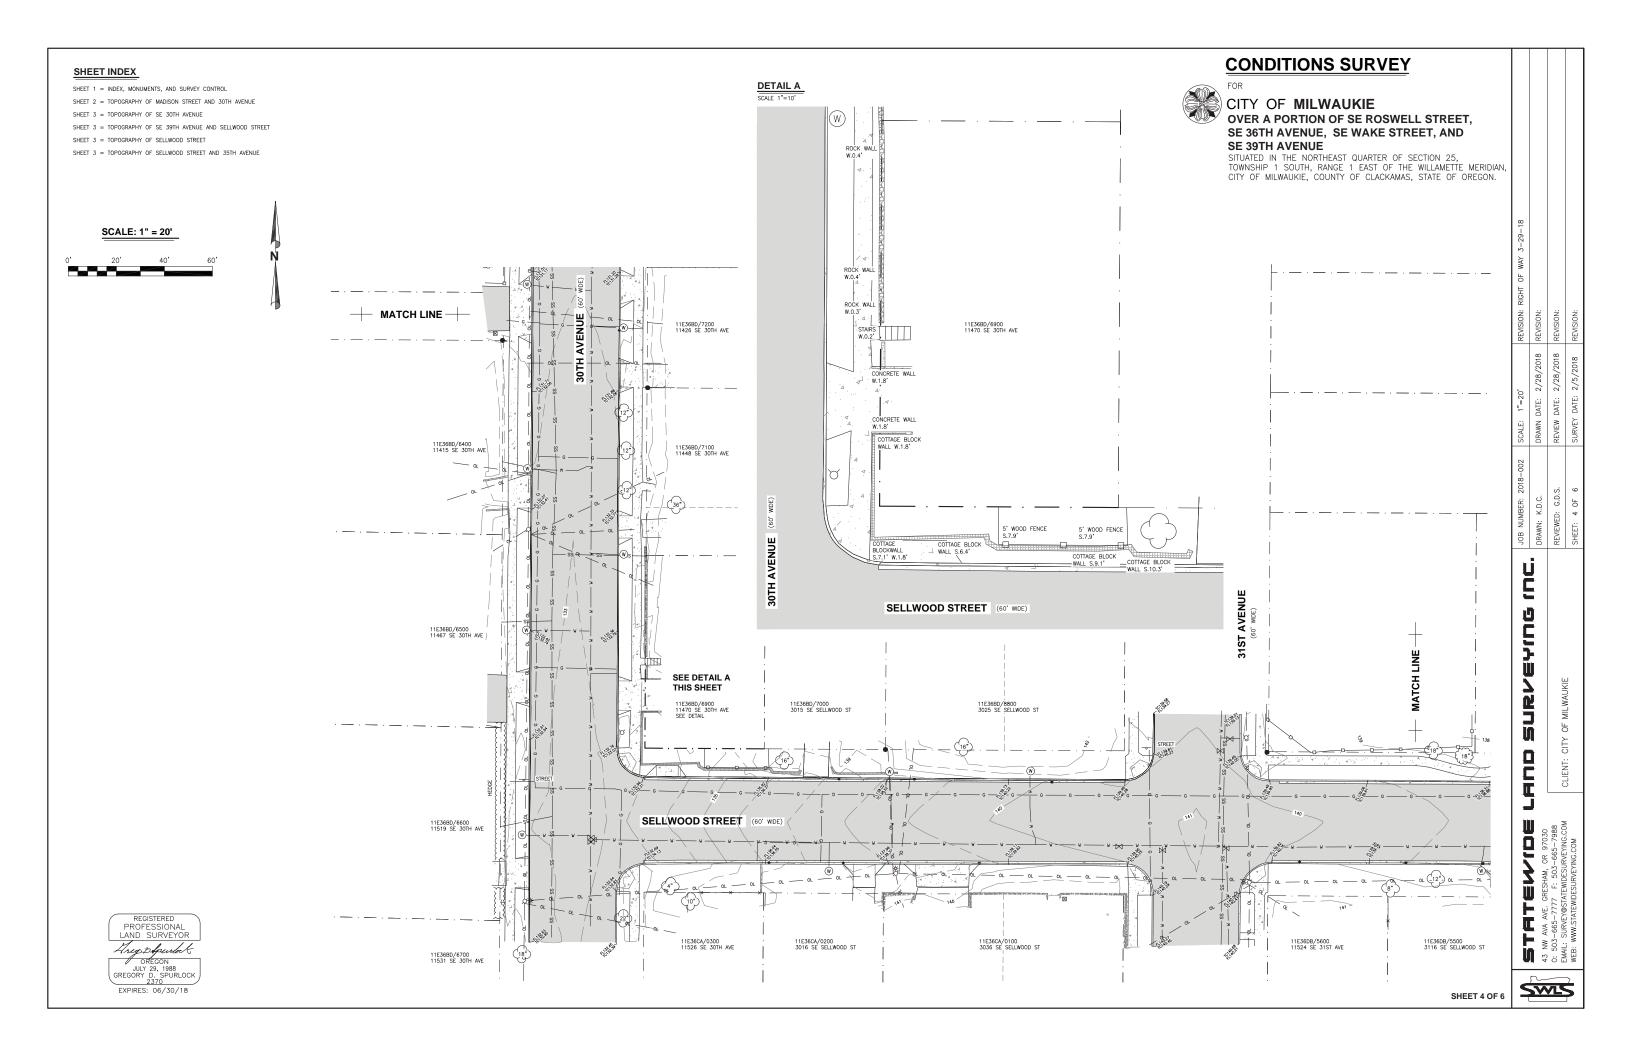6101 SE JOHNSON CREEK BLVD. MILWAUKIE, OR 97206

PHONE: 503-786-7600 FAX: 503-774-8236

TRAFFIC CONTROL PLAN

Sellwood / 30th Ave / Madison SAFE Project

CONTROL DEVICES (MUTCO) AND THE LATEST EDITION OF THE MANUAL ON UNIFORM TRAFFIC CONTROL DEVICES (MUTCO) AND THE LATEST EDITION OF THE OREGON TEMPORARY TRAFFIC CONTROL HANDBOOK (OTTCH) FOR OPERATIONS OF THREE DAYS OR LESS. 3. THESE TRAFFIC CONTROL PLANS ARE SCHEMATIC IN NATURE AND ARE CONSIDERED THE MINIMUM NECESSARY TO


- ADEQUATELY MANAGE TRAFFIC DURING CONSTRUCTION. CONTRACTOR TO PROVIDE FINAL TRAFFIC CONTROL PLAN BEFORE STARTING CONSTRUCTION.
- 4. EACH TRAFFIC CONTROL DETAIL IS TO BE IMPLEMENTED WITH THE ASSOCIATED TYPE OF WORK. FOR EXAMPLE, THE "LANE COONERS AT INTERSECTION WITH FLAGGING" DETAIL CAN BE FLIPPED TO USE ON ANY OF THE FOUR INTERSECTION CORNERS.

 ALL SIGNING, STRIPING, AND PERMANENT BARRICADES TO BE INSTALLED BY THE CONTRACTOR. THE CONTRACTO SUBMIT TRAFFIC CONTROL PLANS FOR THE WORK IN THE RIGHT-OF-WAY AT THE PRE-CONSTRUCTION MEETING. 2. ALL TRAFFIC CONTROL MEASURES SHALL CONFORM WITH THE LATEST. FDITION OF THE MANUAL ON UNIFORM TRAFFIC


TRAFFIC CONTROL NOTES


- 5. CONTRACTOR SHALL INSTALL AND MAINTAIN ALL TRAFFIC CONTROL DEVICES IN ACCORDANCE WITH THE TRAFFIC CONTROL PLAN THROUGHOUT THE DURATION OF CONSTRUCTION.
- 6. ALL TRAVEL LANES, STREETS, SIDEWALKS, DRIVEWAYS, AND POINTS OF ACCESS SHALL BE OPENED TO VEHICULAR TRAFFIC AT THE END OF EACH WORK DAY. ALL AREAS OF EXCAVATION WITHIN THE TRAVELED WAY SHALL BE TEMPORARILY COVERED WITH STEEL PLATES OR BACKFILLED AND TEMPORARILY SURFACED WITH ASPHALT CONCRETE PATCHING UNTIL
- 7. CONTRACTOR SHALL PROVIDE VEHICULAR ACCESS TO SIDE STREETS AND DRIVEWAYS TO THE EXTENT PRACTICABLE. WHEN VEHICULAR ACCESS CANNOT BE PROVIDED, THE CONTRACTOR WILL NOTIFY THE AFFECTED BUSINESS / PROPERTY OWNER OF THE DATE AND DURATION OF THE INTERRUPTION, 14 DAYS IN ADVANCE OF THE CLOSURE.
- 8. TRAFFIC CONTROL DEVICE LOCATIONS ARE APPROXIMATE. FINAL SIGN LOCATION SHALL BE DETERMINED BY CITY
- 9. TRAFFIC CONTROL SIGNS SHALL BE SIZED IN ACCORDANCE WITH CONVENTIONAL ROADWAY STANDARDS OF THE MUTCD.
- 10. TRAFFIC CONTROL SIGNS SHALL BE SPACED IN ACCORDANCE WITH THE MUTCD AND OTTCH FOR 25 MPH VEHICULAR
- 11. LANE SHIFTING AND MERGER TAPERS SHALL HAVE A LENGTH NECESSARY TO ACCOMMODATE 25 MPH VEHICULAR SPEEDS, UNLESS OTHERWISE SPECIFIED IN THE PROJECT PLANS OR AS DIRECTED BY THE PROJECT MANAGER.
- 12. CONE LOCATIONS ARE SCHEMATIC AND DENOTE LANE LOCATIONS, LANE TAPERS, AND WORK AREAS AND DO NOT INDICATE THE NUMBER OF CONES TO BE PLACED. CONTRACTOR WILL PLACE CONES IN A NUMBER SUFFICIENT TO ADEQUATELY DELINEATE AND DIRECT TRAFFIC AROUND WORK AREAS PER THE MUTCD.
- 13. THE MINIMUM VEHICLE TRAVEL LANE WIDTH SHALL BE A 10-FOOT CLEAR DISTANCE PERPENDICULAR TO THE DIRECTION

PROJECT NO.: CIP2018-T41 CONTRACT NO.: SHEET NO .: TR01 DATE: 9/24/2018

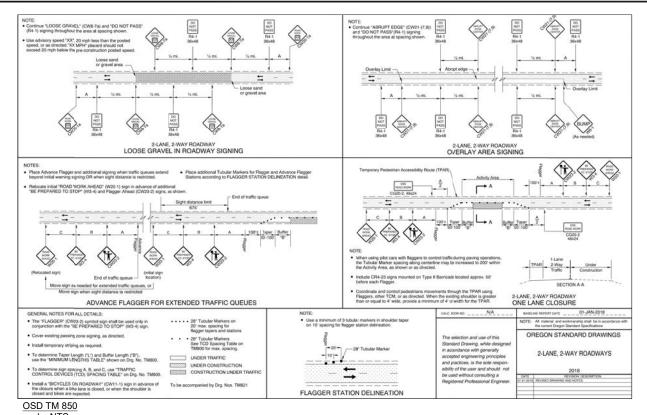


scale: NTS

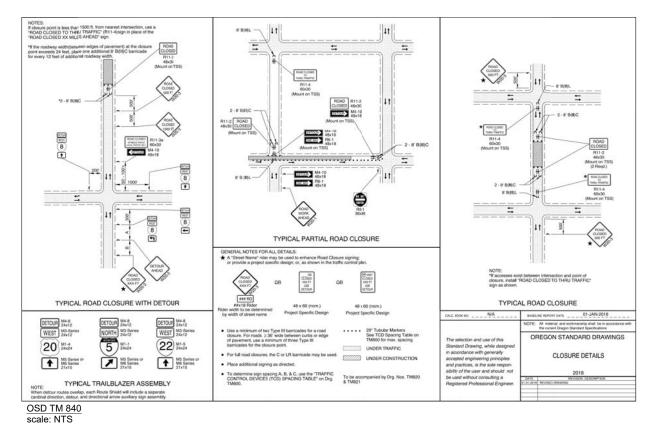

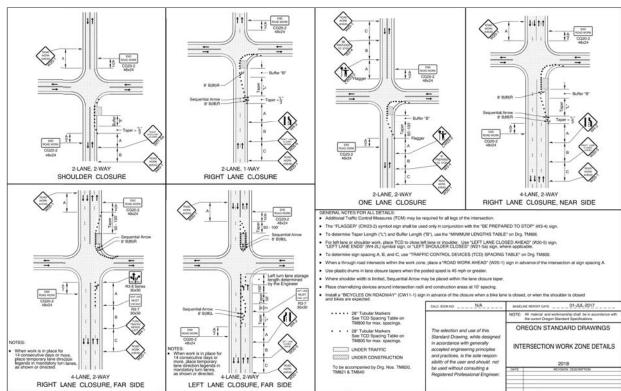

OSD TM 841 scale: NTS

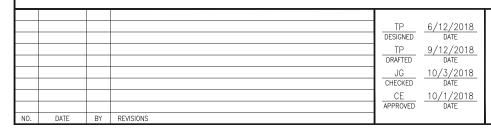





6101 SE JOHNSON CREEK BLVD. MILWAUKIE, OR 97206

Sellwood / 30th Ave / Madison SAFE Project TRAFFIC CONTROL PLAN

PHONE: 503-786-7600 FAX: 503-774-8236 PROJECT NO.: CIP2018-T41

CONTRACT NO.:

DATE:

9/24/2018 SHEET NO.:

TR02

LOGUS RD MONROF ST **PROJECT** LOCATION

SELLWOOD / 30TH AVE. / MADISON SAFE PROJECT

CIP2018-T41

EROSION AND SEDIMENT CONTROL PLANS

DEVELOPER:

NAME CITY OF MILWAUKIE
ADDRESS 10722 SE MAIN STREET
MILWAUKIE OR 97222
PHONE: 503-786-7548
CONTACT: TESSIE PRENTICE

PROPERTY LOCATION:

LATITUDE: 45°26'24"N LONGITUDE: 122*37'55"W

NARRATIVE DESCRIPTION: EXISTING SITE CONDITIONS:

EXISTING CONDITION ON PROJECT SITE IS PAVED ROAD CURBS BOTH SIDES OF THE ROAD. A STORM SYSTEM EXISTS AT THE INTERSECTIONS OF 34TH AVE AND SELLWOOD ST AND 35TH AVE AND SELLWOOD ST. RUNOFF ACCUMULATES AT THE INTERSECTION OF MADISON ST AND 30TH AVE.

DEVELOPED CONDITIONS:

ADDITION OF 3.880 SE NEW IMPERVIOUS SIDEWALK

SITE SOIL CLASSIFICATION:
53B - LATOURELL LOAM, 3 TO 8 PERCENT SLOPES
91B - WOODBURN SILT LOAM, 3 TO 8 PERCENT SLOPES

RECEIVING WATER BODIES:
LOWER JOHNSON CREEK AND KELLOGG CREEK

ENGINEERING:

NAME CITY OF MILWAUKIE
ADDRESS 10722 SE MAIN STREET
MILWAUKIE OR 97222
PHONE: 503-786-7548 CONTACT: TESSIE PRENTICE

SURVEY FIRM:

NAME STATEWIDE LAND SURVEYING, INC ADDRESS 43 NW AVA AVENUE GRESHAM OR 97030

NATURE OF CONSTRUCTION ACTIVITY AND ESTIMATED TIME TABLE *CLEARING AND DEMOLITION: 12/17/18 TO 7/1/19

*GRADING: 12/17/18-8/2/19 *CONSTRUCTION: 12/17/18 TO 7/31/19 *FINAL STABILIZATION: 8/23/19

TOTAL SITE AREA: 150,130 SF = 3.45 ACRES TOTAL DISTURBED AREA: 27,000 SF = 0.62 ACRES

BMP MATRIX FOR CONSTRUCTION PHASES

REFER TO DEQ GUIDANCE MANUAL FOR A COMPREHENSIVE LIST OF AVAILABLE BMP'S.

	CLEARING AND DEMOLITION	GRADING	CONSTRUCTION	FINAL STABILIZATION	WET WEATHER (OCT 1-MAY 31)
EROSION PREVENTION					
PRESERVE NATURAL VEGETATION	**X	X	X	X	X
GROUND COVER				X	X
HYDRAULIC APPLICATIONS					
PLASTIC SHEETING					
MATTING					
DUST CONTROL					
TEMPORARY/ PERMANENT SEEDING				X	X
BUFFER ZONE					
OTHER:					
SEDIMENT CONTROL					
SEDIMENT FENCE					
STRAW WATTLES	X	X	X	X	X
FILTER BERM					
INLET PROTECTION	**X	X	X	X	X
DEWATERING					
SEDIMENT TRAP					
OTHER:					
RUN OFF CONTROL					
CONSTRUCTION ENTRANCE					
PIPE SLOPE DRAIN					
OUTLET PROTECTION					
SURFACE ROUGHENING					
CHECK DAMS					
OTHER:					
POLLUTION PREVENTION					
PROPER SIGNAGE					
HAZ WASTE MGMT					
SPILL KIT ON-SITE					
CONCRETE WASHOUT AREA					
OTHER:					

** SIGNIFIES BMP THAT WILL BE INSTALLED PRIOR TO ANY GROUND DISTURBING ACTIVITY.

INSPECTION FREQUENCY

SITE CONDITION	MINIMUM FREQUENCY
1. ACTIVE PERIOD	DAILY WHEN STORMWATER RUNOFF, INCLUDING RUNOFF FROM SNOWMELT, IS OCCURRING.
PRIOR TO THE SITE BECOMING INACTIVE OR IN ANTICIPATION OF SITE INACCESSIBILITY.	ONCE TO ENSURE THAT EROSION AND SEDIMENT CONTROL MEASURES ARE IN WORKING ORDER. ANY NECESSARY MAINTENANCE AND REPAIR MUST BE MADE PRIOR TO LEAVING THE SITE.
3. INACTIVE PERIODS GREATER THAN SEVEN (7) CONSECUTIVE CALENDAR DAYS.	ONCE EVERY TWO (2) WEEKS.
4. PERIODS DURING WHICH THE SITE IS INACCESSIBLE DUE TO INCLEMENT WEATHER.	IF PRACTICAL, INSPECTIONS MUST OCCUR DAILY AT A RELEVANT AND ACCESSIBLE DISCHARGE POINT OR DOWNSTREAM LOCATION.

- HOLD A PRE-CONSTRUCTION MEETING OF PROJECT CONSTRUCTION PERSONNEL, INCLUDING THE INSPECTOR, TO DISCUSS

- * RETAIN A COPY OF THE ESC PLAN AND ALL REVISIONS ON SITE AND MAKE IT AVAILABLE ON REQUEST TO DEQ, AGENT, OR THE LOCAL MUNICIPALITY. DURING INACTIVE PERIODS OF GREATER THAN SEVEN (7) CONSECUTIVE CALENDAR DAYS, RETAIN THE ESC PLAN AT THE CONSTRUCTION SITE.

 * CHANGES TO THE APPROVED ESC PLAN MUST BE SUBMITTED TO DEQ IN THE FORM OF AN ACTION PLAN.

RATIONALE STATEMENT

A COMPREHENSIVE LIST OF AVAILABLE BEST MANAGEMENT PRACTICES (BMP) OPTIONS BASED ON DEQ'S GUIDANCE MANUAL HAS BEEN REVIEWED TO COMPLETE THIS EROSION AND SEDIMENT CONTROL PLAN. SOME OF THE ABOVE LISTED BMP's WERE NOT CHOSEN BECAUSE THEY WERE DETERMINED TO NOT EFFECTIVELY MANAGE EROSION PREVENTION AND SEDIMENT CONTROL FOR THIS PROJECT BASED ON SPECIFIC SITE CONDITIONS, INCLUDING SOIL CONDITIONS, TOPOGRAPHIC CONSTRAINTS, ACCESSIBILITY TO THE SITE, AND OTHER RELATED CONDITIONS, AS THE PROJECT PROGRESSES AND THERE IS A NEED TO REVISE THE ESC PLAN, AN ACTION PLAN WILL BE SUBMITTED.

INITIAL ____TAP__

PERMITTEE'S SITE INSPECTOR:

CONTRACTOR TO PROVIDE THE FOLLOWING INFORMATION -

PHONE:

CONTACT: E-MAIL:

DESCRIPTION OF EXPERIENCE:

THE PERMITTEE IS REQUIRED TO MEET ALL THE CONDITIONS OF THE DEQ 1200-CN PERMIT. THE ESC PLAN AND GENERAL CONDITIONS HAVE BEEN DEVELOPED TO FACILITATE COMPLIANCE WITH THE 1200-CN PERMIT REQUIREMENTS. IN CASES OF DISCREPANCIES OR OMISSIONS, THE 1200-CN PERMIT REQUIREMENTS SUPERCEDE REQUIREMENTS OF THIS PLAN.

ATTENTION EXCAVATORS

OREGON LAW REQUIRES YOU TO FOLLOW RULES ADOPTED BY THE OREGON UTILITY NOTIFICATION CENTER. THOSE RULES ARE SET FORTH IN OAR 952—001—0010 THROUGH OAR 952—001—0090. YOU MAY OBTAIN COPIES OF THESE RULES FROM THE CENTER BY CALLING 503—232—1987. IF YOU HAVE ANY QUESTIONS ABOUT THE RULES, YOU MAY CONTACT THE CENTER. YOU MUST NOTIFY THE CENTER AT LEAST TWO BUSINESS DAYS, BEFORE COMMENCING AN EXCAVATION. CALL 503—246—6699.





Sellwood / 30th Ave / Madison SAFE Project

EROSION & SEDIMENT CONTROL PLAN COVER SHEET

SHEET NO .:

DATE:

CITY OF MILWAUKIE

6101 SE JOHNSON CREEK BLVD. MILWAUKIE, OR 97206

PHONE: 503-786-7600 FAX: 503-774-8236

CONTRACT NO.:

9/24/2018

EC01

SITE MAP not to scale

VICINITY MAP not to scale

> DATE 10/3/2018 CHECKED DATE CE 10/1/2018 APPROVED DATE

DESIGNED

TP

6/12/2018

DATE

PROJECT NO.: CIP2018-T41

- APPLY TEMPORARY AND PERMANENT SOIL STABILIZATION MEASURES ON ALL DISTURBED AREAS AS GRADING PROGRESSES.
- CONSTRUCTION ACTIVITIES MUST AVOID OR MINIMIZE EXCAVATION AND CREATION OF BARE GROUND FROM OCTOBER 1
 THROUGH MAY 31 EACH YEAR. (SCH A.7.q.i.)
- DURING WET WEATHER PERIODS TEMPORARY STABILIZATION OF THE SITE MUST OCCUR AT THE END OF EACH WORK DAY IF RAINFALL IS FORECAST IN THE NEXT 24 HOURS. (SCH A.7.a.ii.)
- ALL EROSION AND SEDIMENT CONTROLS NOT IN THE DIRECT PATH OF WORK MUST BE INSTALLED PRIOR TO ANY LAND
- PRESERVE EXISTING VEGETATION AND RE-VEGETATE OPEN AREAS WHEN PRACTICABLE BEFORE AND AFTER GRADING OR CONSTRUCTION (SCHA.7.c.iii.1)
- ALL TEMPORARY SEDIMENT CONTROLS MUST REMAIN IN PLACE UNTIL PERMANENT VEGETATION OR OTHER PERMANENT COVERING OF EXPOSED SOIL IS ESTABLISHED. (SCH A.7.c.iii.3.)
- SEDIMENT CONTROLS MUST BE INSTALLED AND MAINTAINED ON ALL DOWN GRADIENT SIDES OF THE CONSTRUCTION SITE AT ALL TIMES DURING CONSTRUCTION. (SCH A.7.d.i.(1))
- ALL ACTIVE CATCH BASINS MUST HAVE SEDIMENT CONTROLS INSTALLED AND MAINTAINED AT ALL TIMES DURING CONSTRUCTION. (SCH A.7.d.i.(2))
- WATERTIGHT TRUCKS MUST BE USED TO TRANSPORT SATURATED SOILS FROM THE CONSTRUCTION SITE. AN APPROVED EQUIVALENT IS TO DRAIN THE SOIL ON-SITE AT A DESIGNATED LOCATION USING APPROPRIATE BMP's: SOIL MUST BE
- 10. TEMPORARY STABILIZATION OR COVERING OF SOIL STOCKPILES MUST OCCUR AT THE END OF EACH WORK DAY OR OTHER BMP's MUST BE IMPLEMENTED TO PREVENT TURBID DISCHARGES TO SURFACE WATERS. (SCH A.7.e.ii.2.)
- 11. DEVELOP AND MAINTAIN ONSITE A WRITTEN SPILL PREVENTION AND RESPONSE PROCEDURE, (SCH A.7.e.iii.3)
- ANY USE OF TOXIC OR OTHER HAZARDOUS MATERIALS MUST INCLUDE PROPER STORAGE, APPLICATION, AND DISPOSAL.
- 13. THE PERMITTEE MUST PROPERLY PREVENT AND MANAGE HAZARDOUS WASTE, USED OILS, CONTAMINATED SOILS, CONCRETE WASTE, SANITARY WASTE, LIQUID WASTE, OR OTHER TOXIC SUBSTANCES DISCOVERED OR GENERATED DURING CONSTRUCTION. (SCH A.7.e.i.1 AND SCH A.7.e.iii.4)
- SIGNIFICANT AMOUNTS OF SEDIMENT WHICH LEAVE THE SITE MUST BE CLEANED UP WITHIN 24 HOURS AND PLACED BACK ON THE SITE AND STABILIZED OR PROPERLY DISPOSED. THE CAUSE OF THE SEDIMENT RELEASE MUST BE FOUND AND PREVENTED FROM CAUSING A REOCCURRENCE OF THE DISCHARGED WITHIN THE SAME 24 HOURS. ANY IN-STREAM CLEAN UP OF SEDIMENT SHALL BE PERFORMED ACCORDING TO THE OREGON DIVISION OF STATE LANDS REQUIRED TIME FRAME.
- SEDIMENT MUST NOT BE INTENTIONALLY WASHED INTO STORM SEWERS, DRAINAGE WAYS, OR WATERBODIES. DRY SWEEPING MUST BE USED TO CLEAN UP RELEASED SEDIMENTS. (SCH A.7.f.i.2)
- THE APPLICATION RATE OF FERTILIZERS USED TO REESTABLISH VEGETATION MUST FOLLOW THE MANUFACTURER'S RECOMMENDATIONS. NUTRIENT RELEASES FROM FERTILIZERS TO SURFACE WATERS MUST BE MINIMIZED. TIME RELEASE FERTILIZERS SHOULD BE USED AND CARE SHOULD BE TAKEN IN THE APPLICATION OF FERTILIZERS WITHIN ANY WATER WAY
- 17. SEDIMENT MUST BE REMOVED FROM BEHIND SEDIMENT FENCE WHEN IT HAS REACHED A HEIGHT OF 1 THE FENCE ABOVE THE GROUND, AND BEFORE FENCE REMOVAL. (SCH A.7.f.ii.1.)
- 18. SEDIMENT MUST BE REMOVED FROM BEHIND BIO BAGS AND OTHER BARRIERS WHEN IT HAS REACHED A HEIGHT OF TWO (2) INCHES AND BEFORE BMP REMOVAL. (SCH A.7.f.ii.2.)
- 19. CLEANING OF TRAPPED CATCH BASINS MUST OCCUR WHEN THE SEDIMENT RETENTION CAPACITY HAS BEEN REDUCED BY FIFTY (50) PERCENT, AND AT COMPLETION OF PROJECT. (SCH A.7.f.ii.3.)
- 20. REMOVAL OF TRAPPED SEDIMENT IN A SEDIMENT BASIN OR SEDIMENT TRAP MUST OCCUR WHEN THE SEDIMENT RETENTION CAPACITY HAS BEEN REDUCED BY FIFTY (50) PERCENT, AND AT COMPLETION OF PROJECT. (SCH A.7.f.ii.3&4)
- 21. DEQ MUST APPROVE OF ANY TREATMENT SYSTEM AND OPERATIONAL PLAN THAT MAY BE NECESSARY TO TREAT TAMINATED CONSTRUCTION DEWATERING OR SEDIMENT AND TURBIDITY IN STORMWATER RUNOFF. (SCH A.7.f.iii.)
- 22. SHOULD ALL CONSTRUCTION ACTIVITIES CEASE FOR THIRTY (30) DAYS OR MORE, THE ENTIRE SITE MUST BE TEMPORARILY STABILIZED USING VEGETATION OR A HEAVY MULCH LAYER, TEMPORARY SEEDING, OR OTHER METHOD. (SCH A.8.a.)
- SHOULD CONSTRUCTION ACTIVITIES CEASE FOR FIFTEEN (15) DAYS OR MORE ON ANY SIGNIFICANT PORTION OF A CONSTRUCTION SITE, TEMPORARY STABILIZATION IS REQUIRED FOR THAT PORTION OF THE SITE WITH STRAW, COMPOST, OR OTHER TACKIFIED COVERING THAT WILL PREVENT SOIL OR WIND EROSION UNTIL WORK RESUMES ON THAT PORTION OF THE

LOCAL AGENCY-SPECIFIC EROSION CONTROL NOTES

- ALL EROSION PREVENTION MEASURES SHALL BE IN PLACE, FUNCTIONAL, AND APPROVED IN ACCORDANCE WITH THE
 APPROVED EROSION PREVENTION AND SEDIMENT CONTROL PLAN PRIOR TO COMMENCEMENT OF CONSTRUCTION ACTIVITIES.
 ALL SOIL DISTURBING AND CONSTRUCTION ACTIVITIES SHALL BE CONDUCTED IN ACCORDANCE WITH MMC CHAPTER 16.28
 EROSION CONTROL AND ANY APPLICABLE LOCAL, STATE, OR FEDERAL REQUIREMENTS.
- ALTERNATE SEDIMENT CONTROLS MUST PROVIDE A DISCHARGE THAT IS CLEAN AND FREE OF SEDIMENT, SURFACTANTS, AND OTHER POLLUTANTS PRIOR TO ENTERING THE STORM SYSTEM. APPROVAL OF ALTERNATIVE SEDIMENT CONTROLS BY THE CITY OF MILWAUKIE WASTEWATER DIVISION MANAGER IS REQUIRED PRIOR TO INSTALLATION.
- DUMPING OR DISPOSAL OF SPOIL MATERIALS INTO ANY STREAM CORRIDOR, WETLAND, SURFACE WATER, OR ON ANY PUBLIC OR PRIVATE PROPERTY NOT SPECIFIED FOR SAID PURPOSE IS PROHIBITED.
- SEDIMENT AND POLLUTANTS SHALL NOT BE WASHED INTO STORM SEWERS, DRAINAGE WAYS, OR WATER BODIES. DRY SWEEPING SHALL BE IMPLEMENTED TO CLEAN UP CONSTRUCTION AREAS TO PREVENT RELEASE OF SEDIMENTS INTO THE
- DISPOSAL OF SEDIMENT LADEN WATER INTO THE WASTEWATER SYSTEM IS PROHIBITED, UNLESS PRIOR WRITTEN APPROVAL IS RECEIVED FROM THE CITY OF MILWAUKIE WASTEWATER DIVISION MANAGER. SEDIMENT LADEN WATER SHALL BE PUMPED THROUGH AN APPROVED SEDIMENT CONTROL BMP PRIOR TO DISPOSAL INTO THE WASTEWATER SYSTEM.
- SAWCUTTING SLURRY AND DEBRIS SHALL BE VACUUMED AND REMOVED FROM ALL IMPERVIOUS SURFACES. VACUUMED SAWCUTTING SLURRY SHALL BE PROPERLY DISPOSED OF AND NOT DISCHARGED INTO THE STORM SYSTEM.
- AN AREA SHALL BE DESIGNATED FOR WASHING OUT CONCRETE TRUCKS SUCH THAT RUNOFF FROM WASHING ACTIVITIES ARE CONTAINED AND DO NOT LEAVE THE SITE OR ENTER THE STORM SYSTEM.
- 8. SWEEPING FROM EXPOSED AGGREGATE CONCRETE SHALL NOT BE WASHED TO THE STREET OR STORM SYSTEM. SWEEPING SHALL BE COLLECTED AND PROPERLY DISPOSED OF IN THE TRASH.
- 9. PAVING IN WET WEATHER WHEN PAVING CHEMICALS CAN RUN OFF INTO THE STORM SYSTEM IS PROHIBITED
- 10. TRACKING OF DIRT AND DEBRIS ONTO IMPERVIOUS SURFACES, SUCH AS STREETS AND PARKING LOTS, IS PROHIBITED. IMPERVIOUS SURFACES SHALL BE KEPT FREE OF DIRT AND DEBRIS AT ALL TIME IF IT CAN BE SPREAD BY TRAFFIC OR
- 11. GRAVEL OR DIRT CURB RAMPS ARE PROHIBITED. ONLY WOOD STEP STYLE CURB RAMPS ARE ALLOWED.
- 12. UPON COMPLETION OF SITE RESTORATION AND APPROVAL FROM THE CITY OF MILWAUKIE ENGINEERING DIRECTOR, ALL TEMPORARY EROSION CONTROL MEASURES MAY BE REMOVED.
- 13. DRAINAGE FROM SPRINGS OR GROUNDWATER MUST BE ADDRESSED DURING CONSTRUCTION BY THE CONTRACTOR. DISCHARGE FROM GROUNDWATER ENCOUNTERED ON THE SITE MUST BE CLEAN OF SEDIMENT OR POLLUTANTS.
- 14. AREA SUBJECT TO WIND EROSION SHALL USE APPROPRIATE DUST CONTROL MEASURES INCLUDING THE APPLICATION OF A FINE SPRAY OF WATER, PLASTIC SHEETING, STRAW MULCH, OR OTHER APPROVED MEASURE.
- 15. DATES OF IMPLEMENTATION OF WET WEATHER MEASURES ARE OCTOBER 1ST TO APRIL 30TH.
- 16. MATERIAL SHALL NOT BE STOCKPILED ON PUBLIC STREETS OR IN THE RIGHT-OF-WAY LONGER THAN IMMEDIATE USE.
- 17. PRIOR TO ANY LAND DISTURBING ACTIVITIES, THE BOUNDARIES OF THE CLEARING LIMITS, VEGETATED BUFFERS, AND ANY SENSITIVE AREAS SHOWN ON THIS PLAN SHALL BE CLEARLY DELINEATED IN THE FIELD. DURING THE CONSTRUCTION PERIOD, NO DISTURBANCE IS PERMITTED BEYOND THE CLEARING LIMITS. THE CONTRACTOR MUST MAINTAIN THE DELINEATION FOR THE PROPERTY OF THE PROPE
- 18. PRIOR TO ANY LAND DISTURBING ACTIVITIES, THE BMP's THAT MUST BE INSTALLED ARE A GRAVEL CONSTRUCTION ENTRANCE, PERIMETER SEDIMENT CONTROL, AND INLET PROTECTION AS SPECIFIED. THESE BMP's MUST BE MAINTAINED FOR
- 19. IF VEGETATIVE SEED MIXES ARE SPECIFIED, SEEDING MUST TAKE PLACE NO LATER THAT SEPTEMBER 1; THE TYPE AND PERCENTAGES OF SEED IN THE MIX MUST BE IDENTIFIED ON THE PLANS WITH AN ESTABLISHED HEALTHY STAND OF GRASS OF 80% COVERAGE BY OCTOBER 1ST.
- 20. ALL PUMPING OF SEDIMENT LADEN WATER SHALL BE DISCHARGED OVER AN UNDISTURBED, PREFERABLY VEGETATED AREA, AND THROUGH A SEDIMENT CONTROL BMP i.e. (FILTER BAG).
- 21. IF WATER OF THE STATE IS WITHIN THE PROJECT SITE OR WITHIN 50 FEET OF THE PROJECT BOUNDARY, MAINTAIN THE EXISTING NATURAL BUFFER WITHIN THE 50-FOOT ZONE FOR THE DURATION OF THE PERMIT COVERAGE, OR MAINTAIN LESS THAN THE ENTIRE EXISTING NATURAL BUFFER AND PROVIDE ADDITIONAL EROSION AND SEDIMENT CONTROL BMPS.
- 22. THE ESC PLAN MUST BE KEPT ON SITE. ALL MEASURES SHOWN ON THE PLAN MUST BE INSTALLED PROPERLY TO ENSURE THAT SEDIMENT OR SEDIMENT LADEN WATER DOES NOT ENTER A SURFACE WATER SYSTEM, ROADWAY, OR OTHER

PRE-CONSTRUCTION, CLEARING AND DEMOLITION NOTES:

- ALL BASE ESC MEASURES MUST BE IN PLACE, FUNCTIONAL, AND APPROVED IN AN INITIAL INSPECTION, PRIOR TO
- 2. SEDIMENT BARRIERS APPROVED FOR USE INCLUDE THE MATERIALS LISTED IN SECTION 00280.16 (E) OF THE CURRENT EDITION OF THE OREGON STANDARD SPECIFICATIONS FOR CONSTRUCTION.
- SENSITIVE RESOURCES INCLUDING, BUT NOT LIMITED TO, TREES, WETLANDS, AND RIPARIAN PROTECTION AREAS SHALL BE CLEARLY DELINEATED WITH ORANGE CONSTRUCTION FENCING OR CHAIN LINK FENCING IN A MANNER THAT IS CLEARLY VISIBLE TO ANYONE I THE AREA. NO ACTIVITIES ARE PERMITTED TO OCCUR BEYOND THE CONSTRUCTION BARRIER.
- 4. CONSTRUCTION ENTRANCES SHALL BE INSTALLED AT THE BEGINNING OF CONSTRUCTION AND MAINTAINED FOR THE DURATION OF THE PROJECT. ADDITIONAL MEASURES MAY BE REQUIRED TO INSURE THAT ALL PAVED AREAS ARE KEPT CLEAN FOR THE DURATION OF THE PROJECT. RUN-ON AND RUN-OFF CONTROLS SHALL BE IN PLACE AND FUNCTIONING PRIOR TO BEGINNING SUBSTANTIA
- CONSTRUCTION ACTIVITIES. RUN-ON AND RUN-OFF CONTROL MEASURES INCLUDE THOSE MATERIALS LISTED IN SECTION 00280.15 OF THE CURRENT EDITION OF THE OREGON STANDARD SPECIFICATIONS FOR CONSTRUCTION. 6. ITEMS NOTED FOR REMOVAL OR DEMOLITION TO BE DISPOSED OF IN A MANNER THAT MEETS APPLICABLE STATE AND
- 7. INSTALLATION AND APPROVAL OF ALL TREE PROTECTION AND ESC MEASURES ARE NEEDED BEFORE CONSTRUCTION BEGINS
- UNDERGROUND AND OVERHEAD POWER LINES AND FRANCHISE UTILITIES ARE LOCATED WITHIN RIGHT-OF-WAY ADJACENT TO THE PROJECT SITE. COORDINATE WORK WITH THE UTILITY COMPANY.

TREE REMOVAL AND PRESERVATION NOTES

- 1. CONTRACTOR SHALL INSTALL 4' HIGH ORANGE TREE PROTECTION FENCING AROUND ALL TREES TO REMAIN ON SITE DURING CONSTRUCTION. FENCING SHALL BE PLACED AT THE TREE DRIP LINE. COORDINATE TREE PROTECTION FENCING LOCATION WITH PROJECT ARBORIST.
- INSTALLATION AND APPROVAL OF ALL TREE PROTECTION AND ESC MEASURES ARE NEEDED BEFORE CONSTRUCTION BEGINS.
- TREE REMOVAL OPERATIONS SHALL NOT DAMAGE TREES TO BE SAVED
- ALL DEMOLITION AND TREE REMOVAL WITHIN THE TREE PROTECTION FENCING SHALL BE COMPLETED UNDER THE SUPERVISION OF THE PROJECT ARBORIST. NO REMOVAL OF ANY STRUCTURES OR TREES SHALL BE PERFORMED WITHOUT THE PROJECT ARBORIST ON SITE.

GRADING, STREET, AND UTILITY ESC CONSTRUCTION NOTES:

- 1. SEED USE FOR TEMPORARY OR PERMANENT SEEDING SHALL BE COMPOSED OF ONE OF THE FOLLOWING MIXTURES, UNLESS
 - VEGETATED CORRIDOR AREAS REQUIRE NATIVE SEED MIXES.
 DWARF GRASS MIX (MIN 100 LB/AC)
 - - 1. DWARF PERENNIAL RYEGRASS (80% BY WEIGHT)
 - 2. CREEPING RED FESCUE (20% BY WEIGHT)
 - C. STANDARD HEIGHT GRASS MIX (MIN 100 LB/AC)

 1. ANNUAL RYEGRASS (40% BY WEIGHT)

 - 2. TURF-TYPE FESCUE (60% BY WEIGHT)
- SLOPE TO RECEIVE TEMPORARY OR PERMANENT SEEDING SHALL HAVE THE SURFACE ROUGHENED BY MEANS OF TRACK-WALKING OR THE USE OF OTHER APPROVED IMPLEMENTS. SURFACE ROUGHENING IMPROVES SEED BEDDING AND REDUCES RUN-OFF VELOCITY.
- LONG TERM SLOPE STABILIZATION MEASURES SHALL INCLUDE THE ESTABLISHMENT OF PERMANENT VEGETATIVE COVER VIA HYDROSEEDING TO 2000 LBS/ACRES WITH AN ADDED TACKIFIER.
- TEMPORARY SLOPE STABILIZATION MEASURES SHALL INCLUDE: COVERING EXPOSED SOIL WITH PLASTIC SHEETING, STRAW MULCHING, WOOD CHIPS, OR OTHER APPROVED MEASURES.
- STOCKPILED SOIL OR STRIPPINGS SHALL BE PLACED IN A STABLE LOCATION AND CONFIGURATION. STOCKPILES SHALL BE COVERED WITH PLASTIC SHEETING OR STRAW MULCH. SEDIMENT FENCE IS REQUIRED AROUND THE PERIMETER OF THE
- EXPOSED CUT OR FILL AREAS SHALL BE STABILIZED THROUGH THE USE OF TEMPORARY SEEDING AND MULCHING, EROSION CONTROL BLANKETS OR MATS, MID-SLOPE SEDIMENT FENCES OR WATTLES, OR OTHER APPROPRIATE MEASURES. SLOPES EXCEEDING 25% MAY REQUIRE ADDITIONAL EROSION CONTROL MEASURES.
- AREAS SUBJECT TO WIND EROSION SHALL USE APPROPRIATE DUST CONTROL MEASURES INCLUDING THE APPLICATION OF A FINE SPRAY OF WATER, PLASTIC SHEETING, STRAW MULCHING, OR OTHER APPROVED MEASURES.
- CONSTRUCTION ENTRANCES SHALL BE INSTALLED AT THE BEGINNING OF CONSTRUCTION AND MAINTAINED FOR THE DURATION OF THE PROJECT. ADDITIONAL MEASURES INCLUDING, BUT NOT LIMITED TO, TIRE WASHES, STREET SWEEPING, AND VACUUMING MAY BE REQUIRED TO INSURE THAT ALL PAVED AREAS ARE KEPT CLEAN FOR THE DURATION OF THE PROJECT.
- ACTIVE INLETS TO STORM WATER SYSTEMS SHALL BE PROTECTED THROUGH THE USE OF APPROVED INLET PROTECTION
- 10. SATURATED MATERIALS THAT ARE HAULED OFF-SITE MUST BE TRANSPORTED IN WATER-TIGHT TRUCKS TO ELIMINATE SPILLAGE OF SEDIMENT AND SEDIMENT-LADEN WATER.
- AN AREA SHALL BE PROVIDED FOR THE WASHING OUT OF CONCRETE TRUCKS IN A LOCATION THAT DOES NOT PROVIDE RUN-OFF THAT CAN ENTER THE STORM WATER SYSTEM. IF THE CONCRETE WASH-OUT AREA CAN NOT BE CONSTRUCTED GREATER THAN 50 FEET FROM ANY DISCHARGE POINT, SECONDARY MEASURES SUCH AS BERMS OR TEMPORARY SETTLING PTS. MAY BE REQUIRED. THE WASH-OUT SHALL BE LOCATED WITHIN SIX FEET OF TRUCK ACCESS AND BE CLEANED WHEN
- 12. SWEEPING FROM EXPOSED AGGREGATE CONCRETE SHALL NOT BE TRANSFERRED TO THE STORM WATER SYSTEM. SWEEPINGS SHALL BE PICKED UP AND DISPOSED IN THE TRASH.
- 13. AVOID PAVING IN WET WEATHER WHEN PAVING CHEMICALS CAN RUN-OFF INTO THE STORM WATER SYSTEM.
- 14. USE BMPs SUCH AS CHECK-DAMS, BERMS, AND INLET PROTECTION TO PREVENT RUN-OFF FROM REACHING DISCHARGE
- 15. COVER CATCH BASINS, MANHOLES, AND OTHER DISCHARGE POINTS WHEN APPLYING SEAL COAT, TACK COAT, ETC. TO PREVENT INTRODUCING THESE MATERIALS TO THE STORM WATER SYSTEM.
- 16. CONTRACTOR TO PROTECT UICs AND DRYWELLS DURING CONSTRUCTION TO PREVENT SEDIMENT FROM ENTERING STRUCTURES.
- 17. AFTER OCTOBER 1ST, COVER AREAS AT FINAL GRADE WITH SEED/STRAW MULCH AT 4000 LBS/ACRE.

UTILITY STATEMENT:

THE UNDERGROUND UTILITIES SHOWN HAVE BEEN MAPPED FROM FIELD SURVEY INFORMATION, OBSERVED ABOUT GROUND EVIDENCE AND GROUND MARKINGS BY OTHERS, AND EXISTING DRAWINGS SUPPLIED BY OTHERS. THE SURVEYOR MAKES NO GUARANTEE THAT THE UNDERGROUND UTILITIES SHOWN COMPRISE ALL SUCH UTILITIES IN THE AREA, EITHER IN SERVICE OR ABANDONED. THE SURVEYOR FURTHER DOES NOT WARRANT THAT THE UNDERGROUND UTILITIES SHOWN ARE IN THE EXACT LOCATION INDICATED BUT DOES CERTIFY THAT THEY ARE LOCATED AS ACCURATELY AS POSSIBLE FROM INFORMATION AVAILABLE. THE SURVEYOR HAS NOT PHYSICALLY LOCATED THE UNDERGROUND UTILITIES.



6/12/2018 DATE DESIGNED ΤP DRAFTED 10/3/2018 DATE CHECKED

DATE BY REVISIONS



CE APPROVED

10/1/2018 DATE

CITY OF MILWAUKIE

EROSION & SEDIMENT CONTROL PLAN NOTES

Sellwood / 30th Ave / Madison SAFE Project

EC02

6101 SE JOHNSON CREEK BLVD. MILWAUKIE, OR 97206


FAX: 503-774-8236


PHONE: 503-786-7600


PROJECT NO.: CIP2018-T41


CONTRACT NO .:

DATE: 9/24/2018 SHEET NO .:

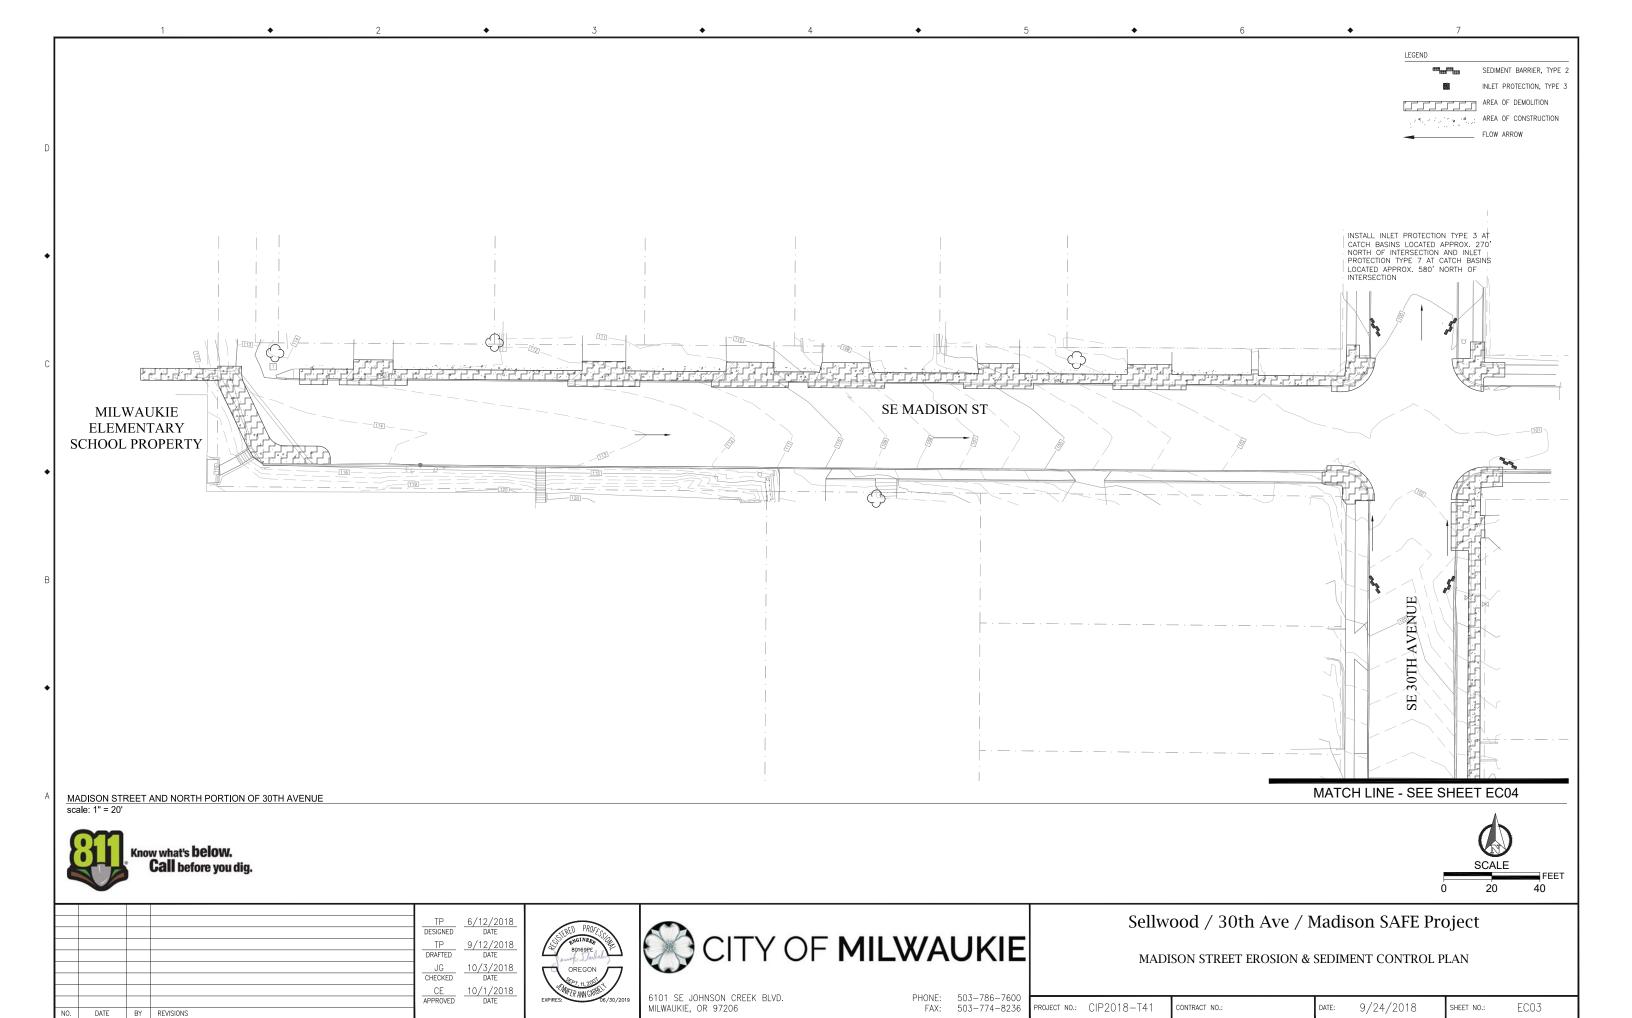


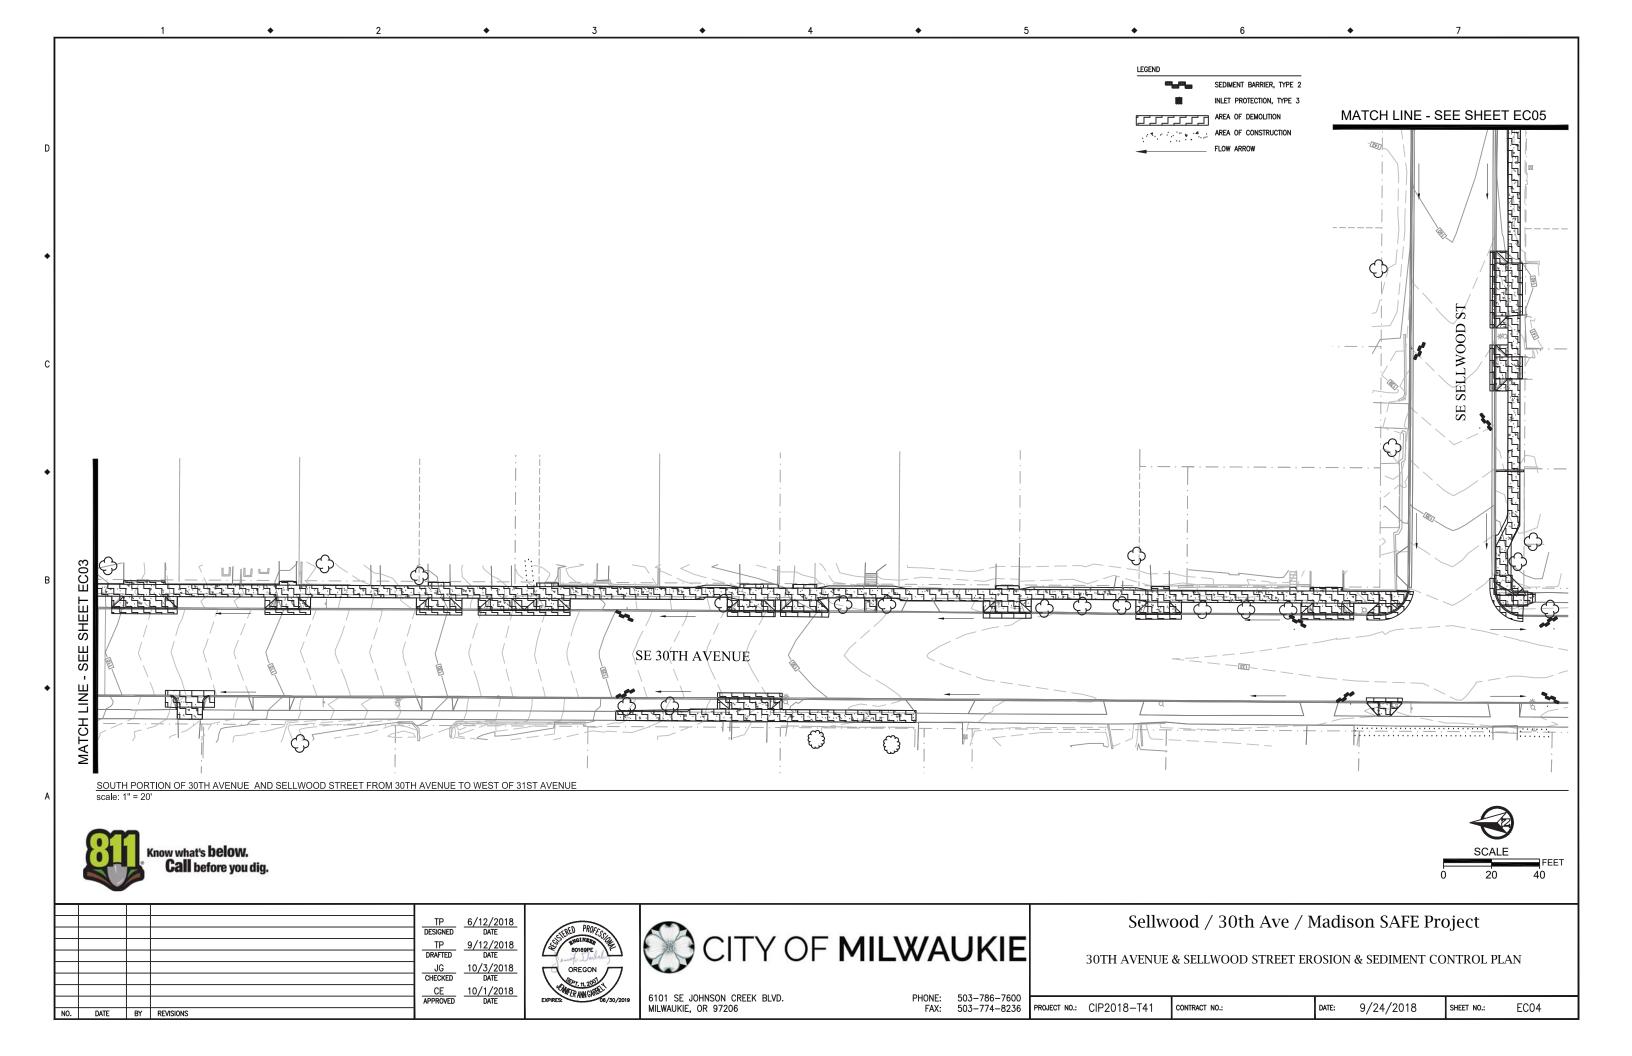

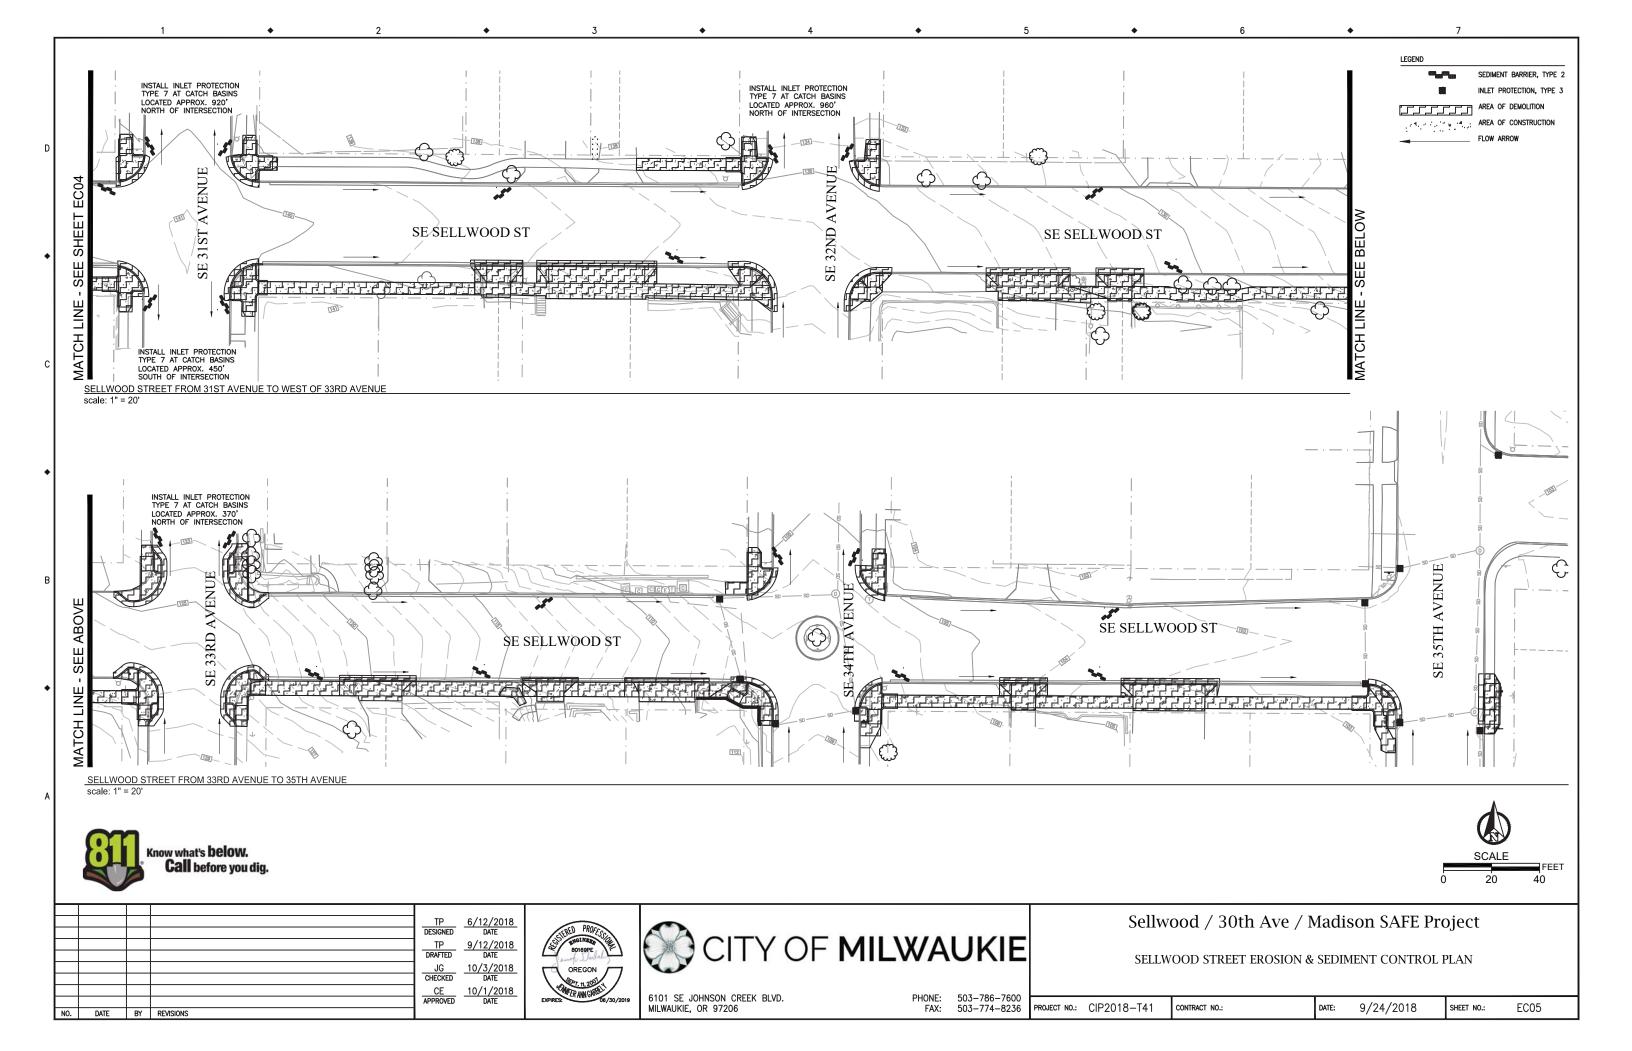

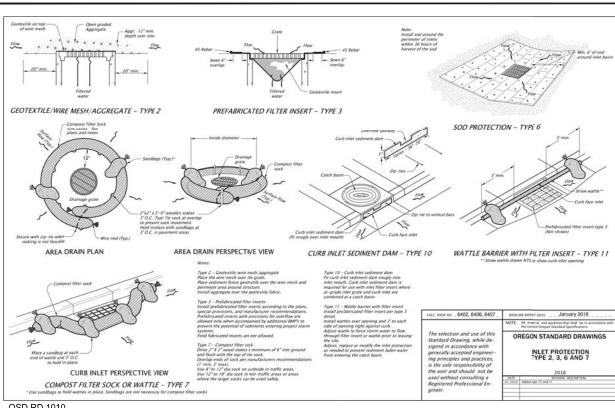

OSD RD 1010 scale: NTS

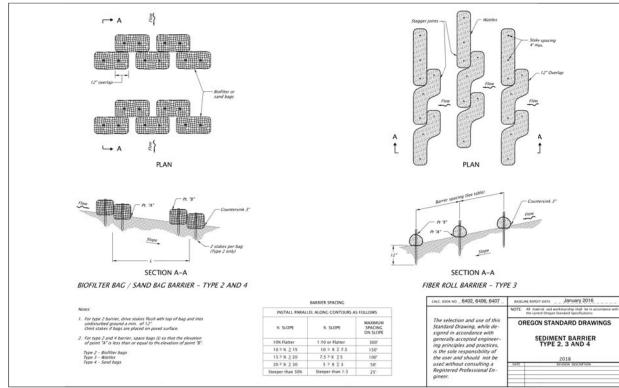

OSD RD 1030 scale: NTS

				TP	6/12/2018
				DESIGNED	DATE
				TP	9/12/2018
				DRAFTED	DATE
				JG	10/3/2018
				CHECKED	DATE
				CE	10/1/2018
				APPROVED	DATE
NO.	DATE	BY	REVISIONS		





6101 SE JOHNSON CREEK BLVD. MILWAUKIE, OR 97206 PHONE: 503-786-7600 FAX: 503-774-8236 Sellwood / 30th Ave / Madison SAFE Project

EROSION & SEDIMENT CONTROL DETAILS


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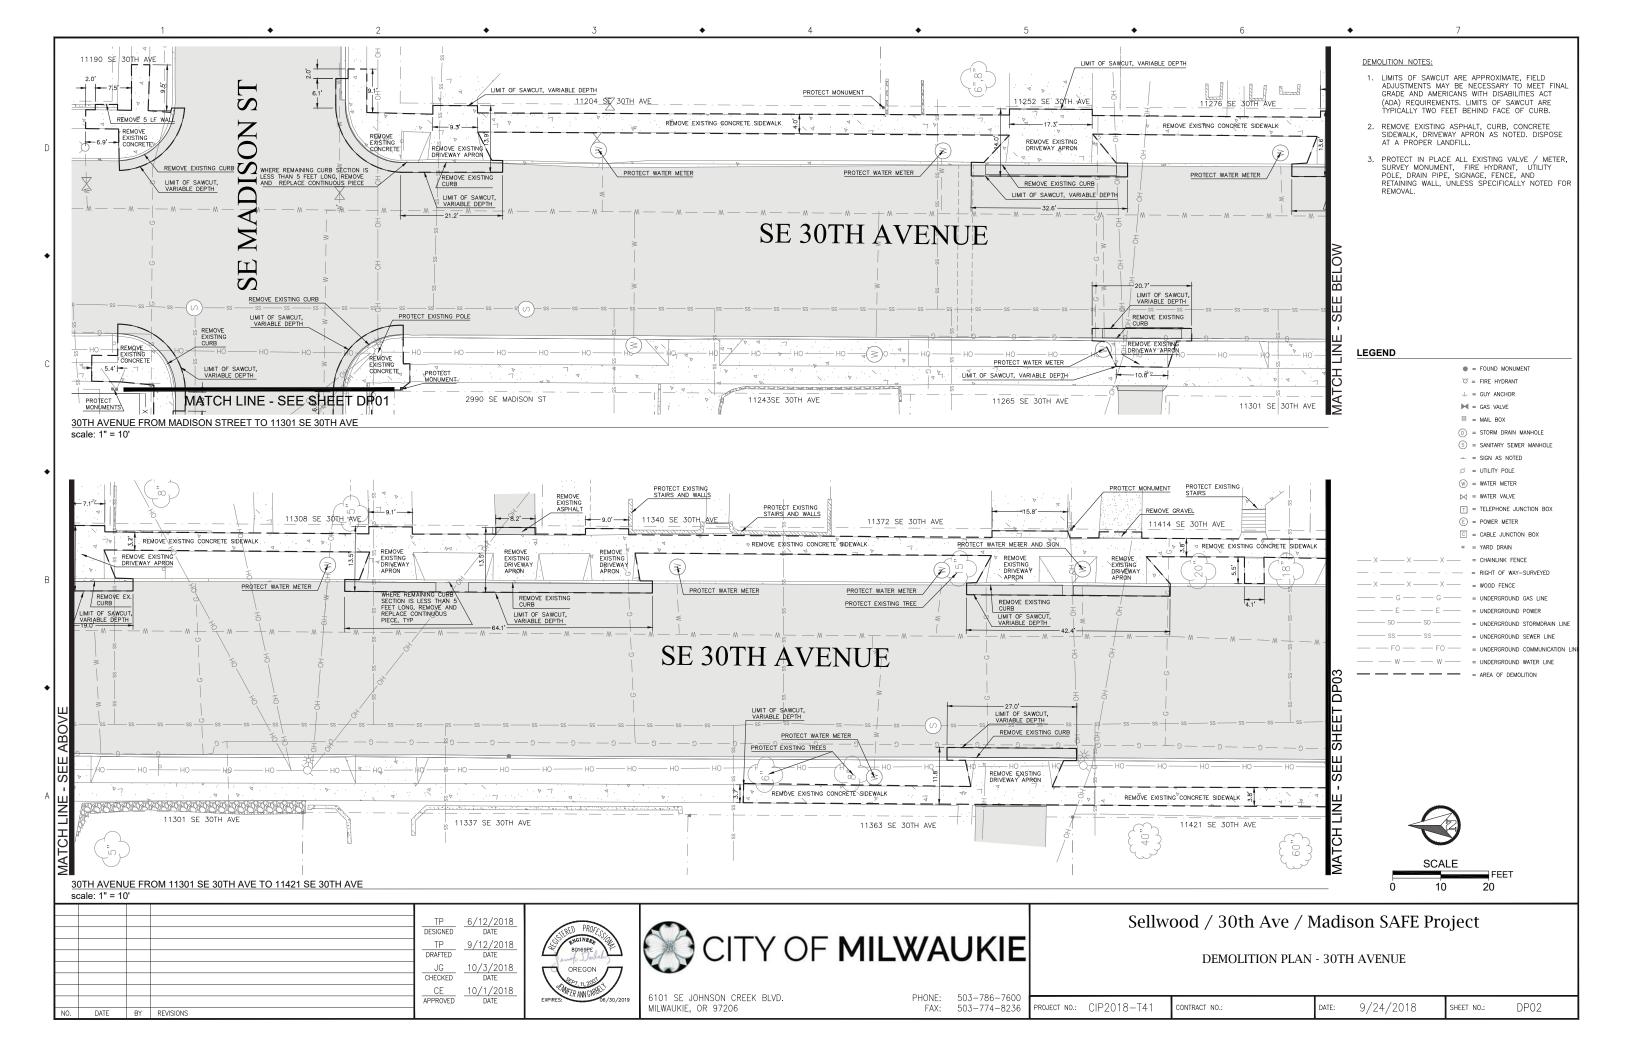
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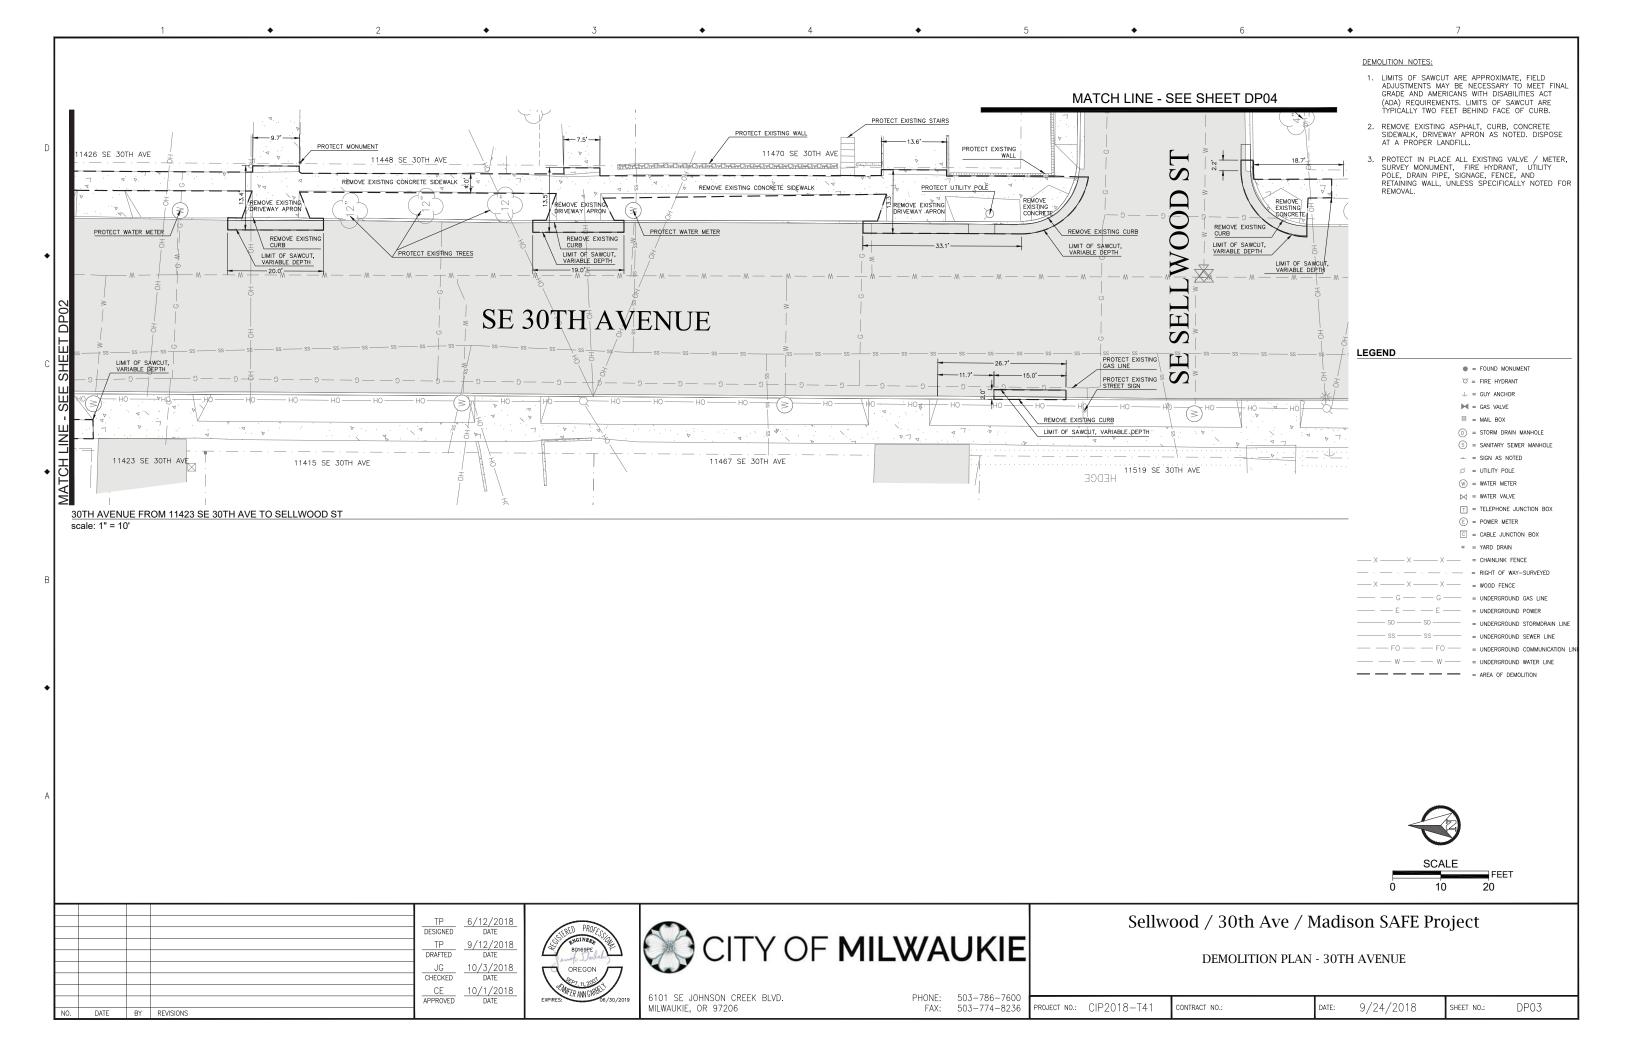
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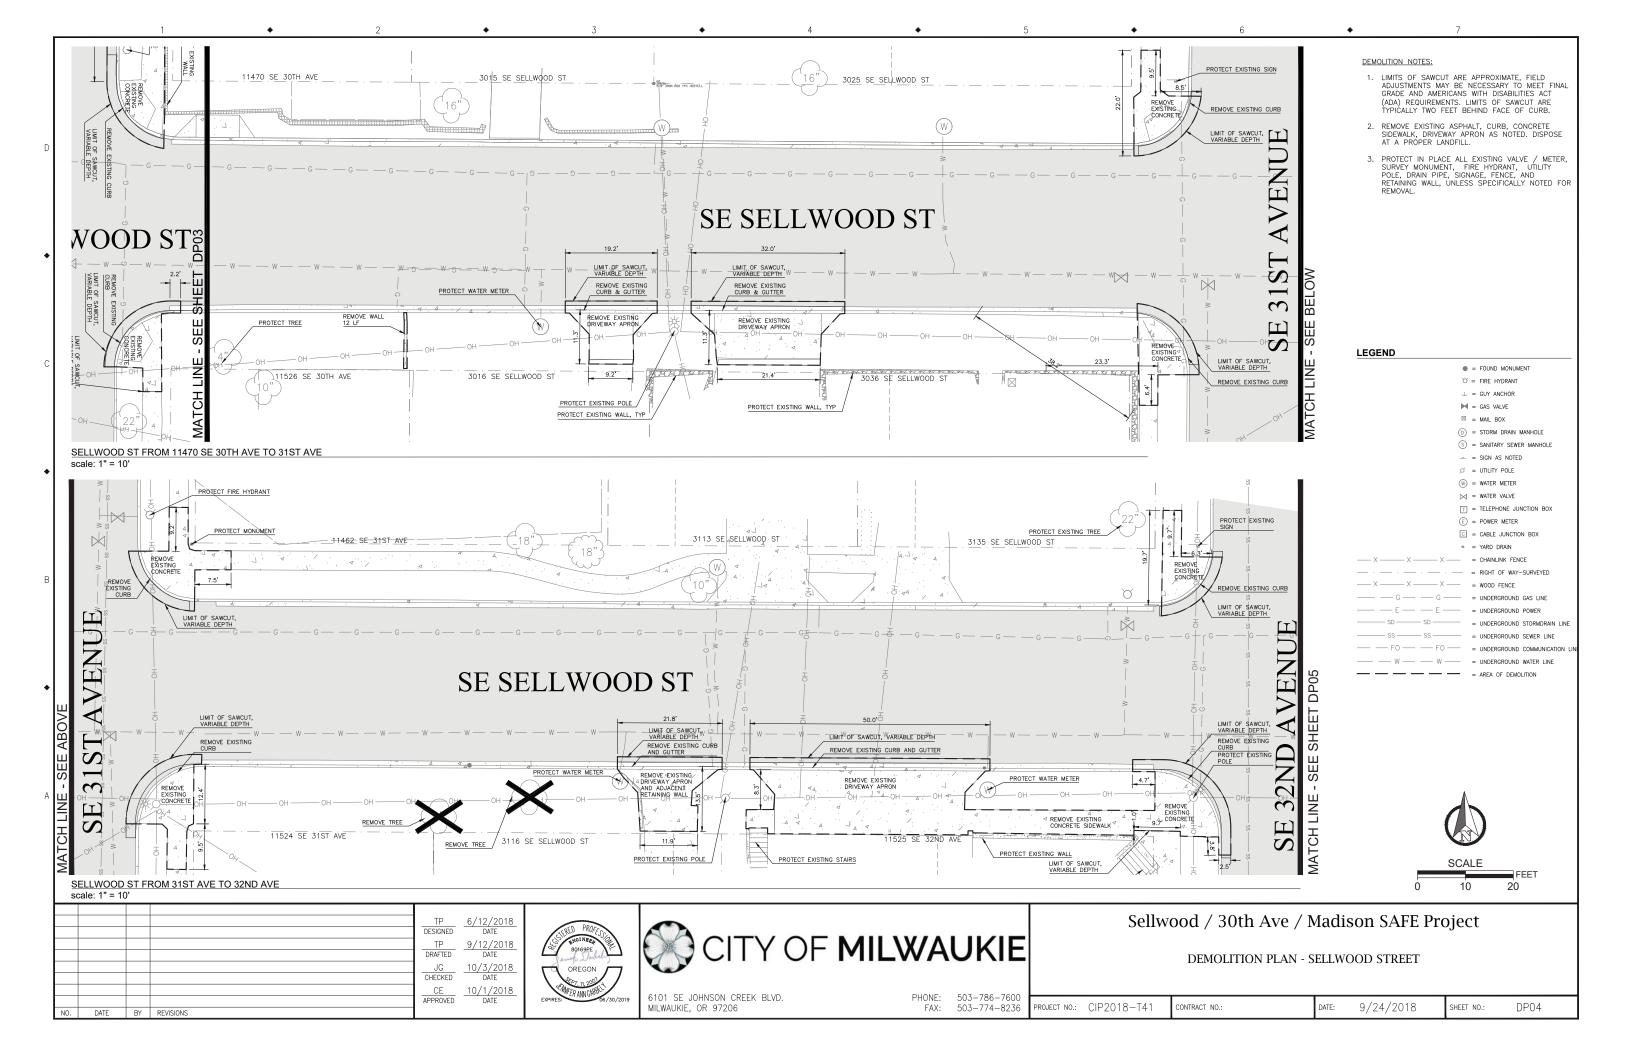
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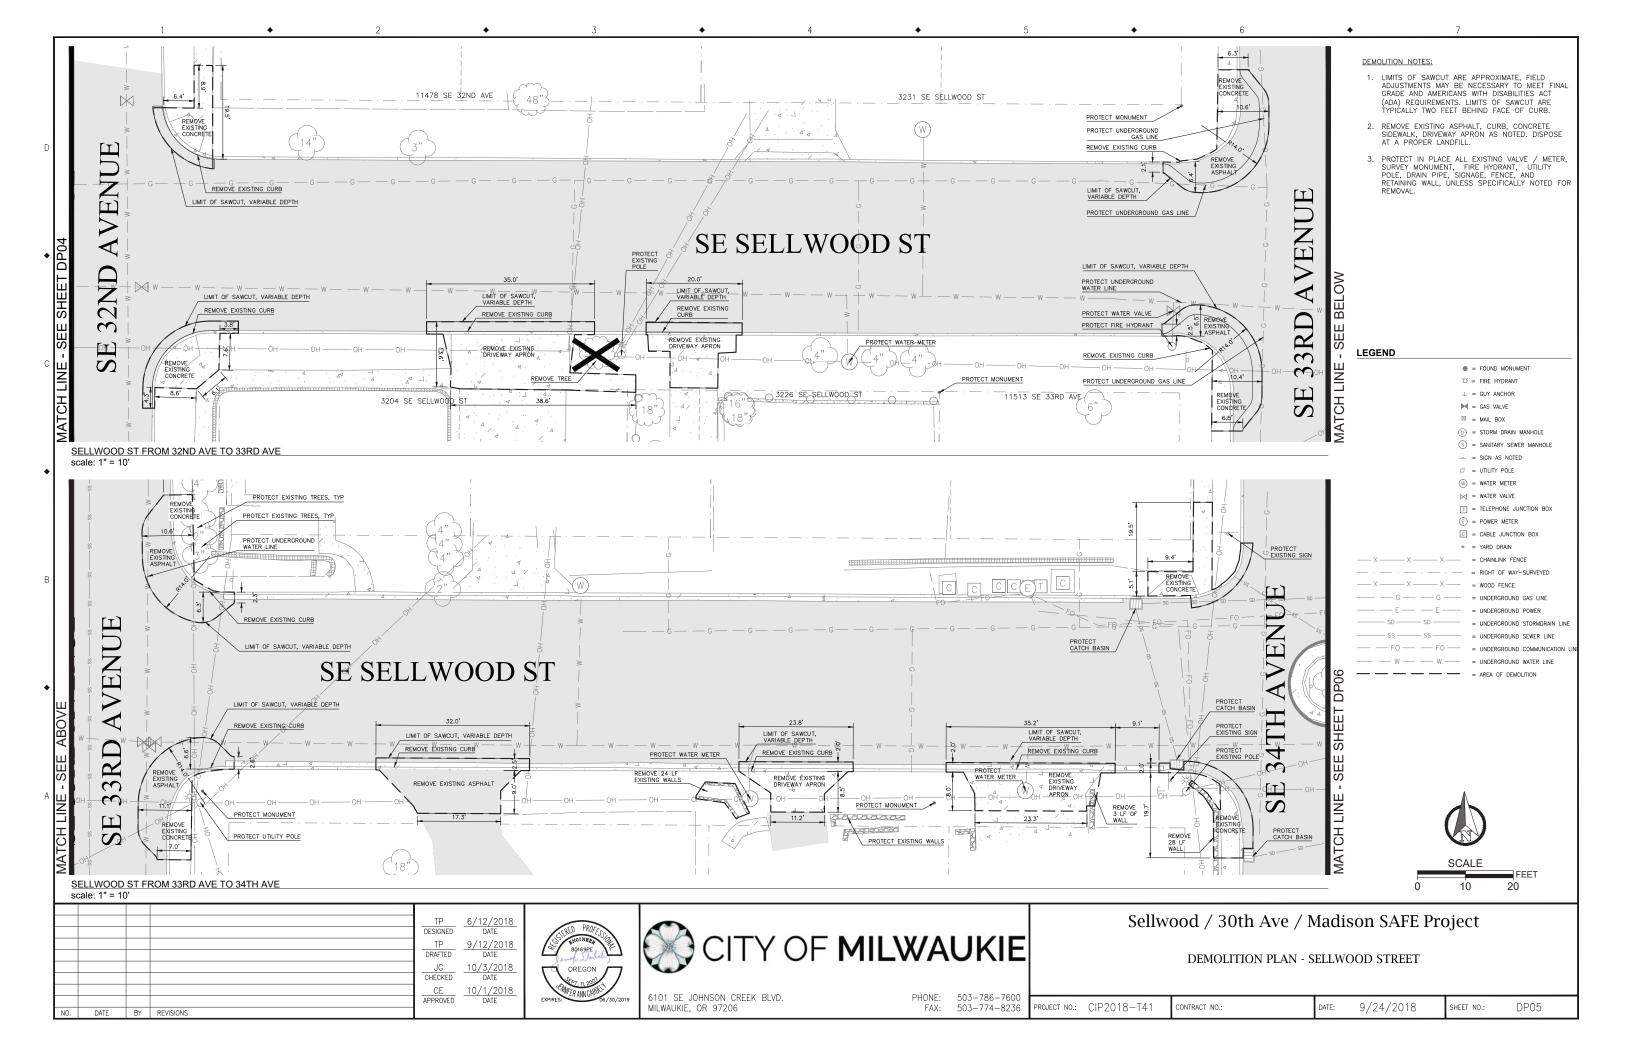
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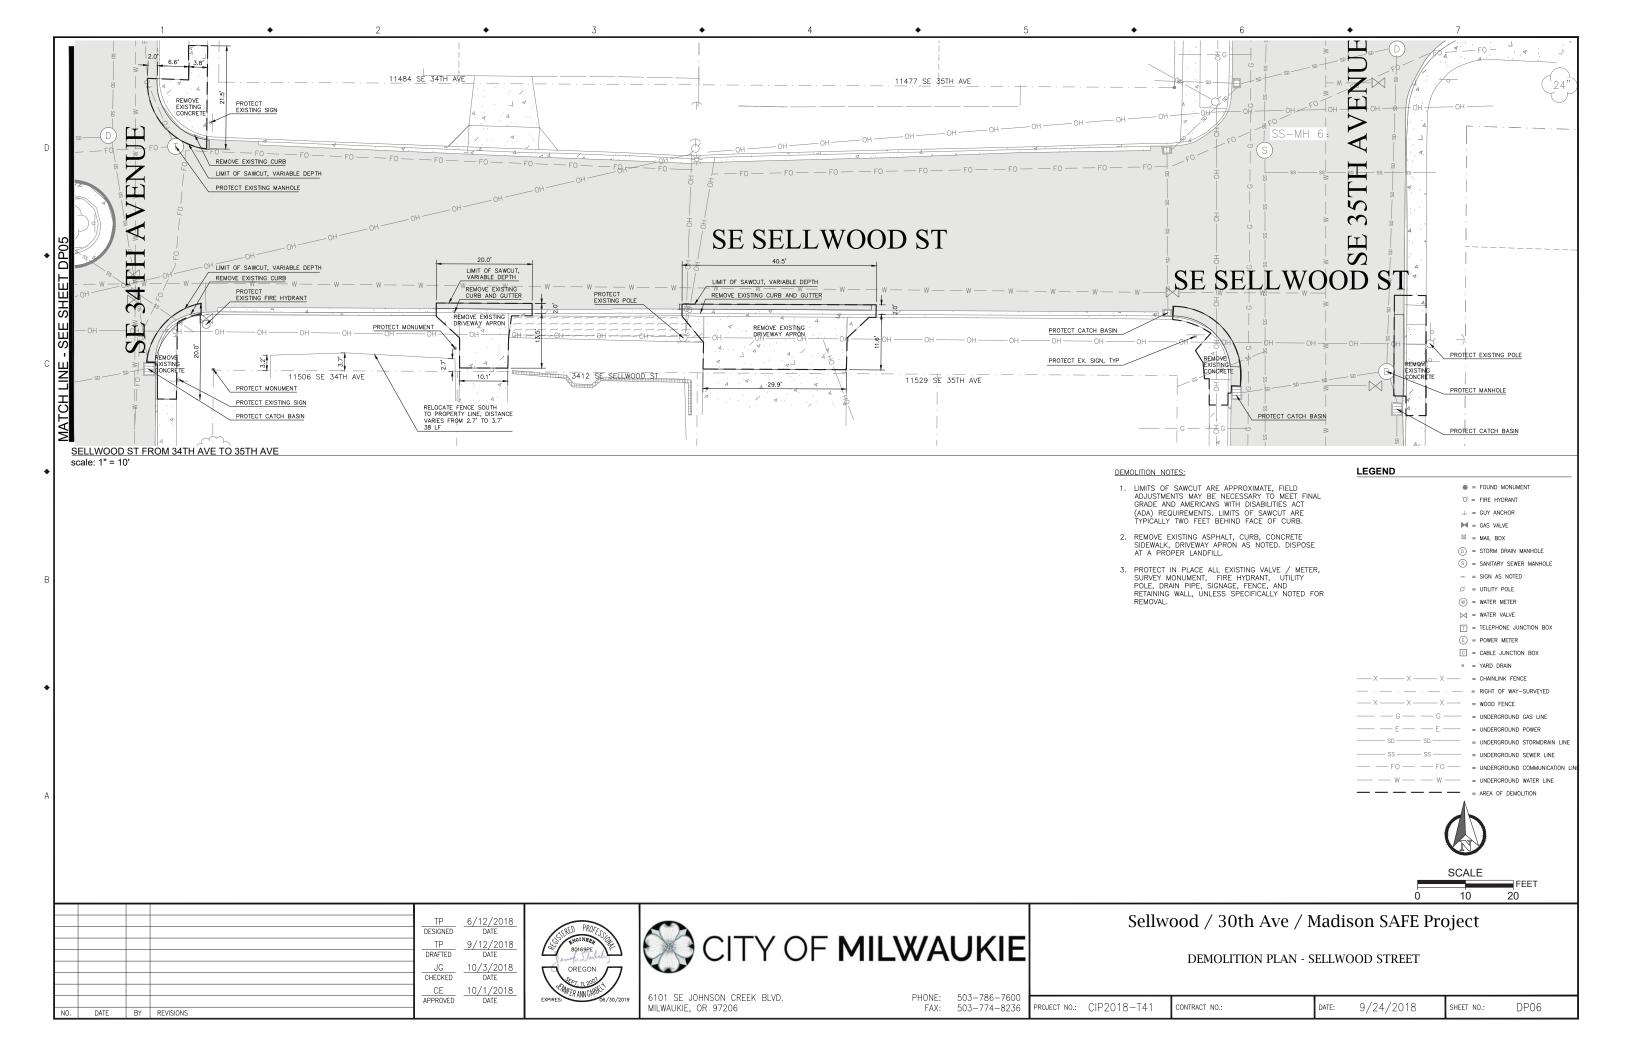














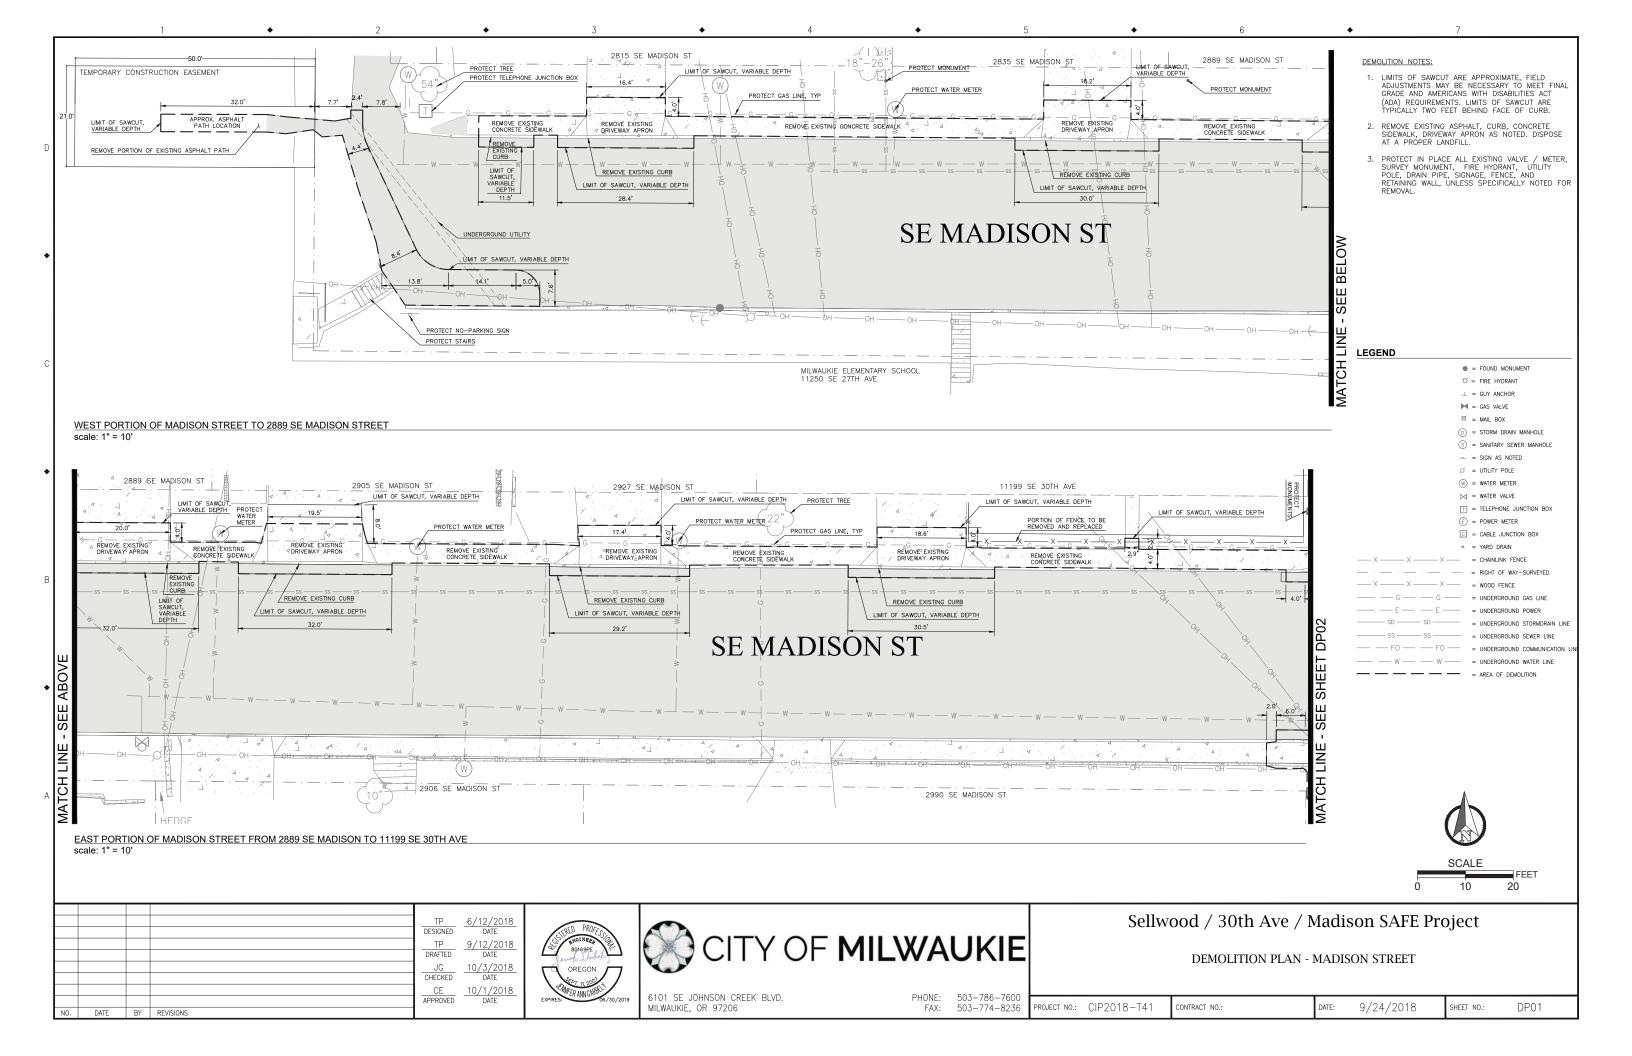


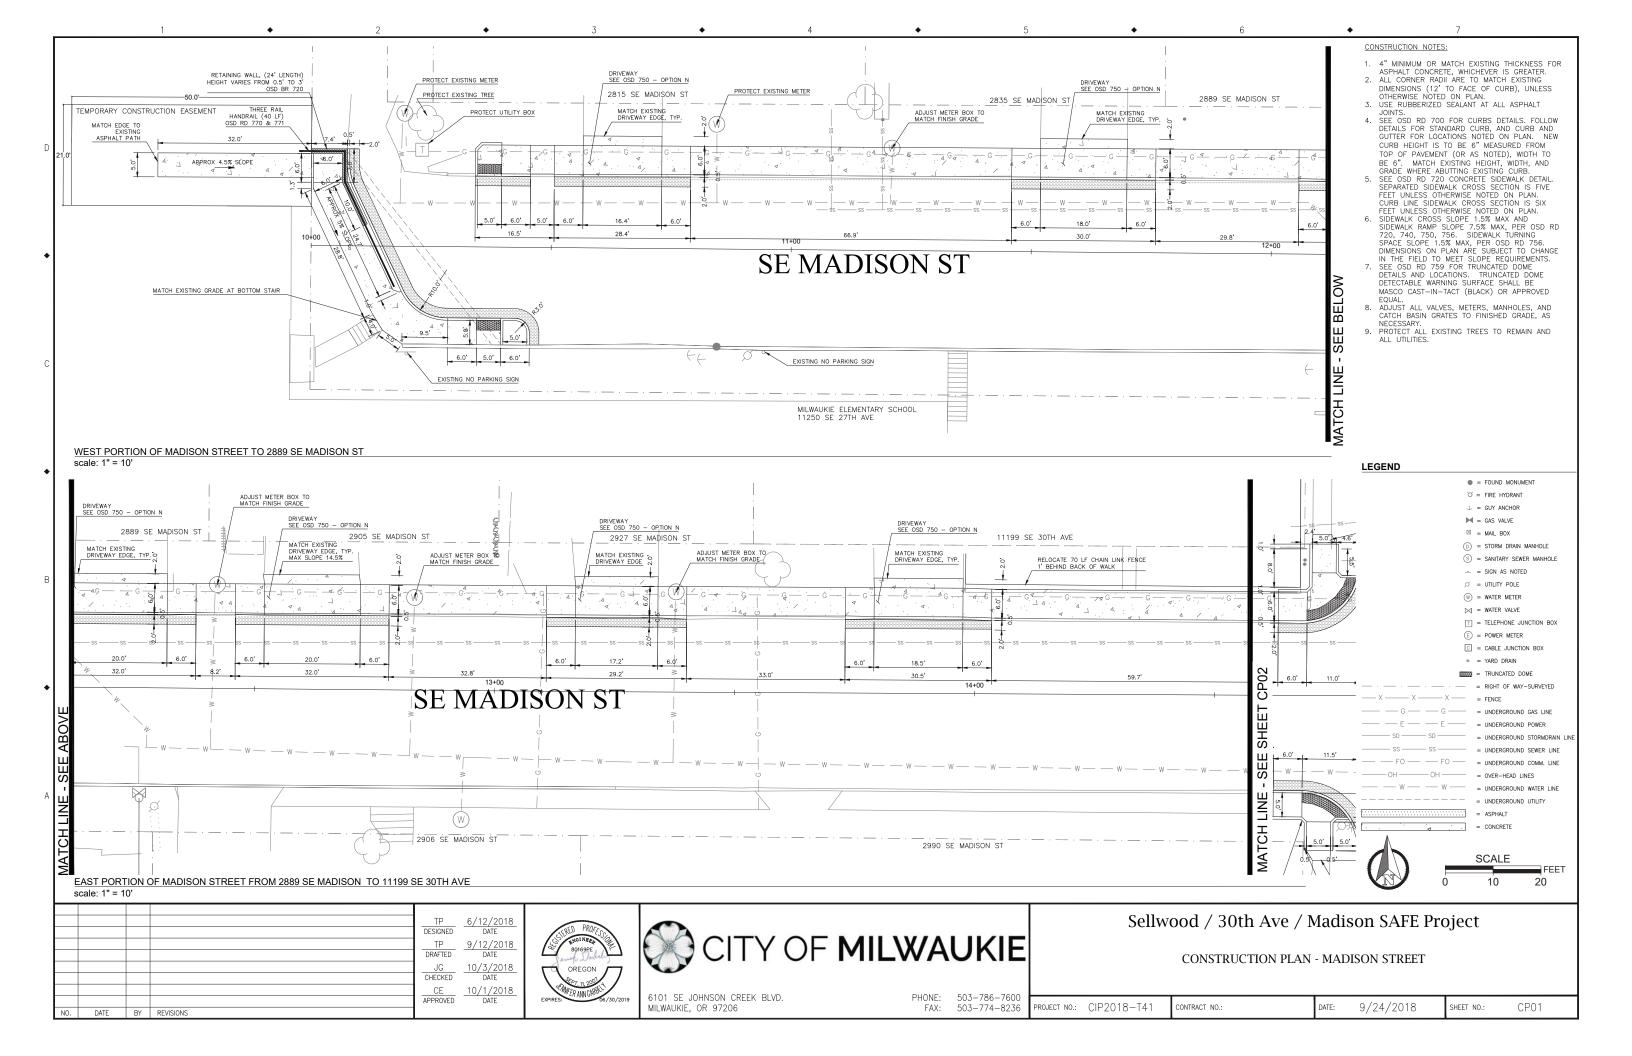


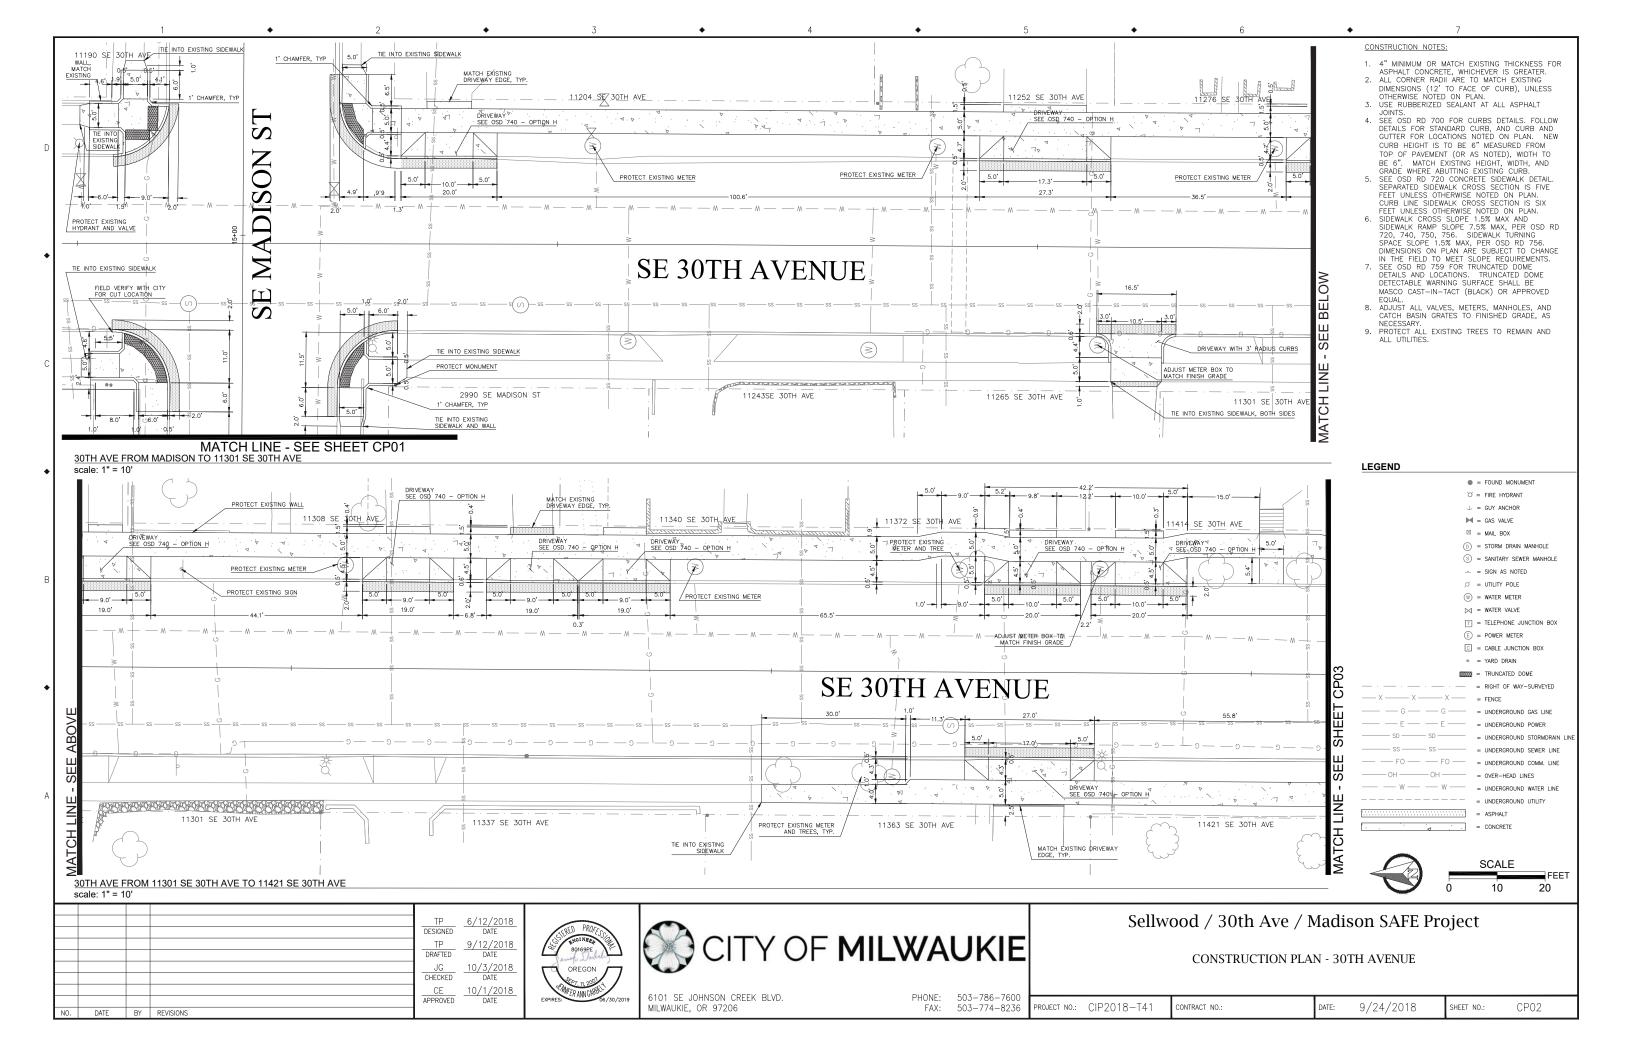


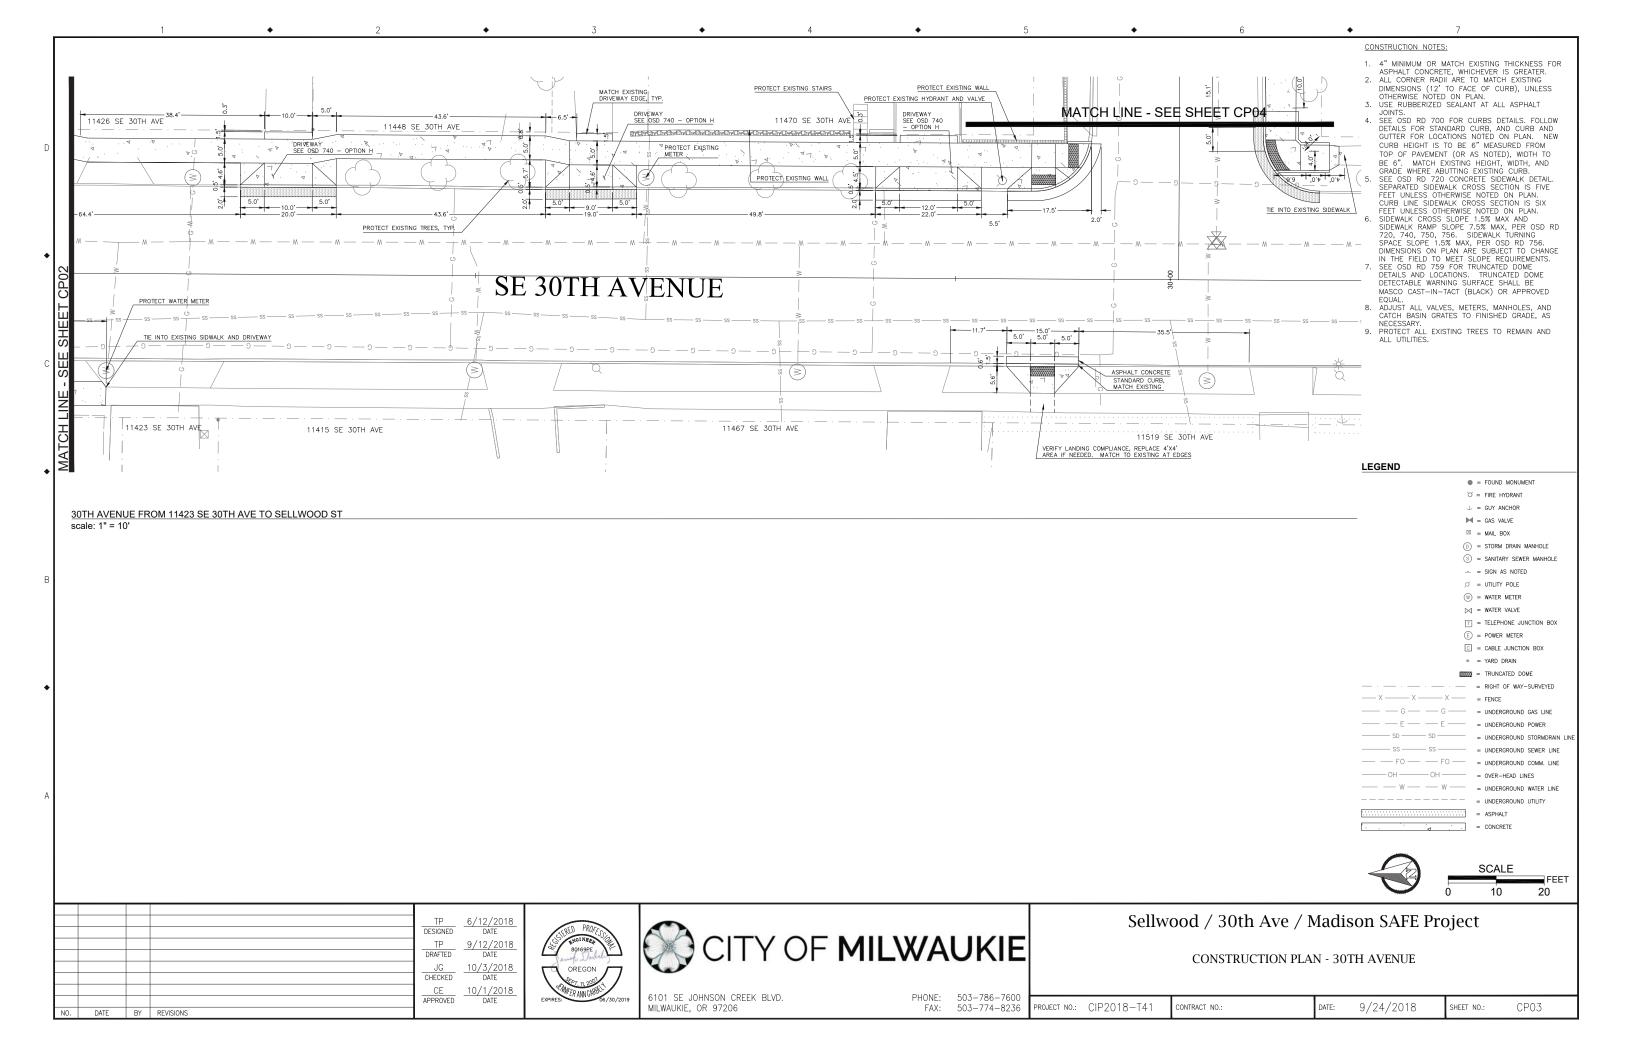


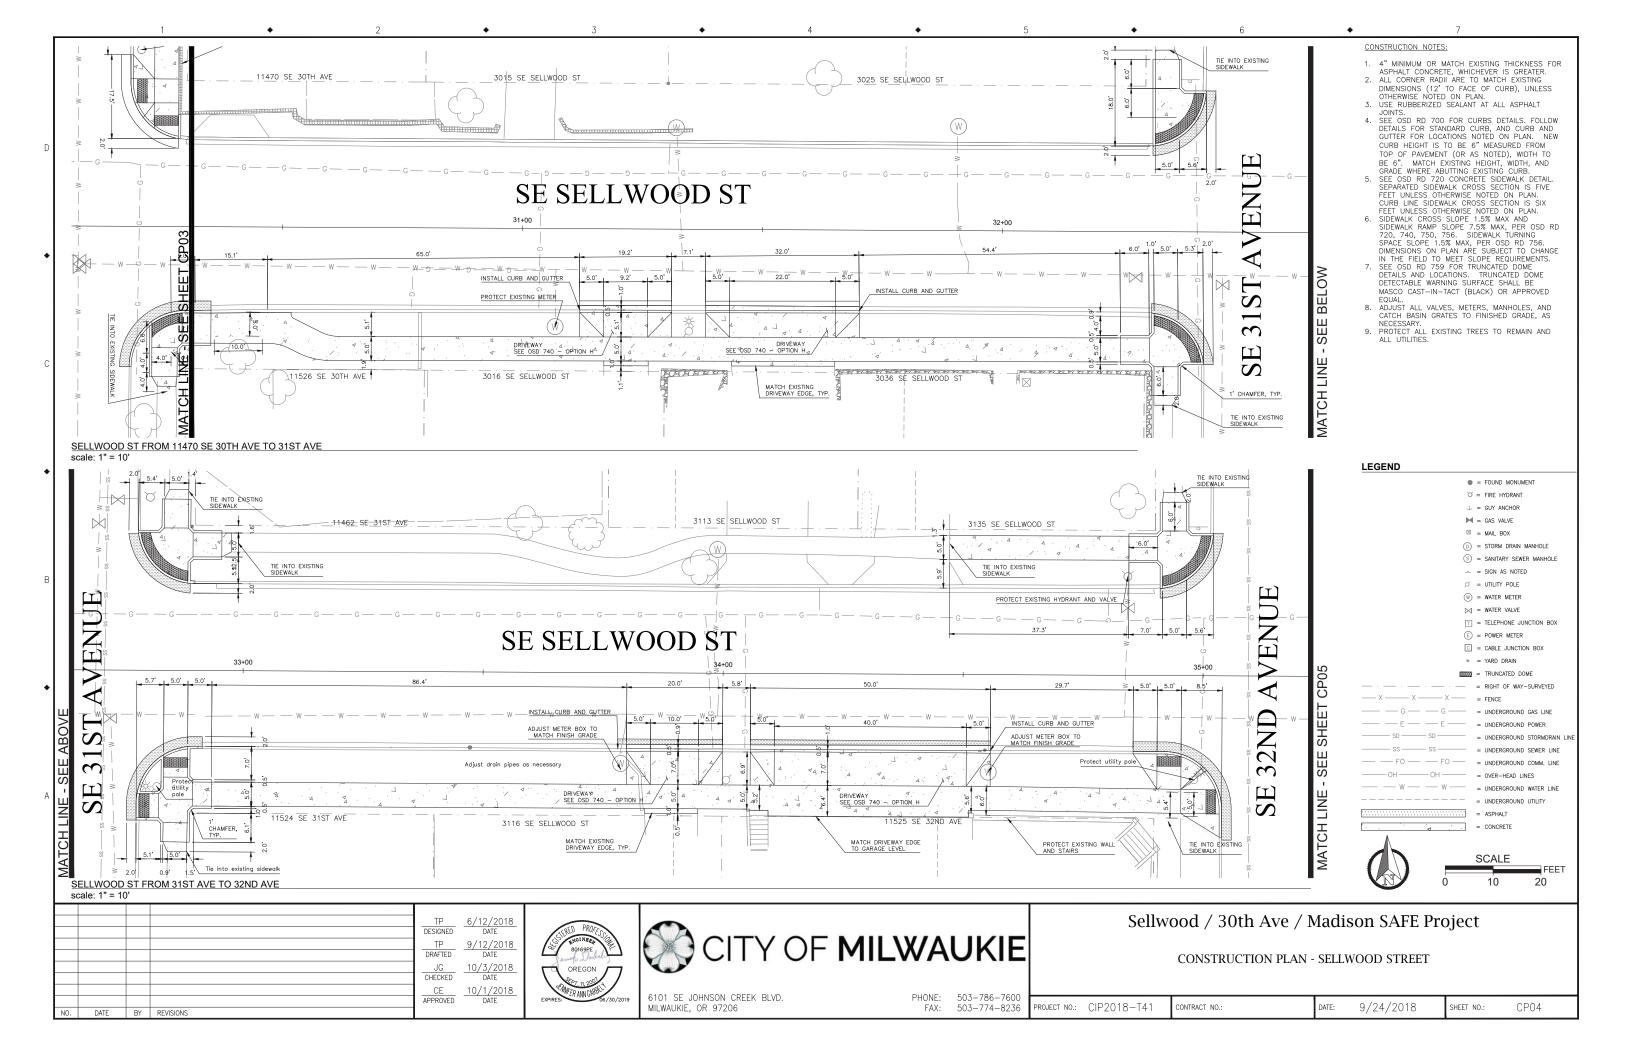

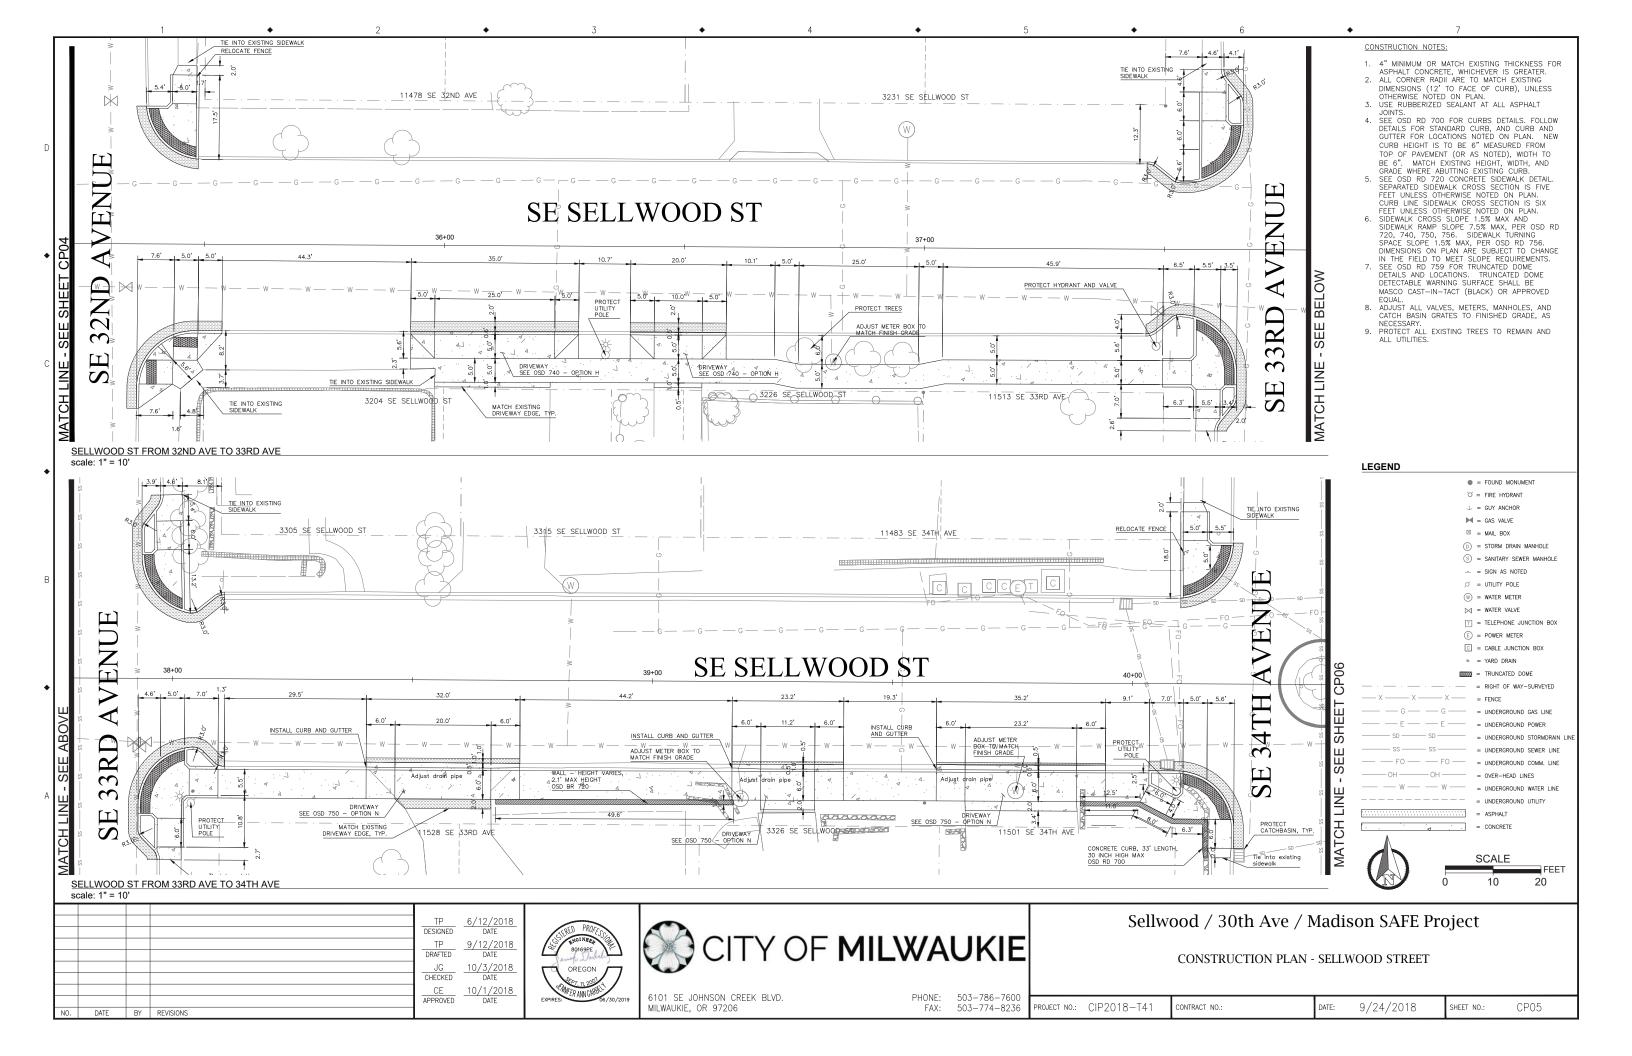

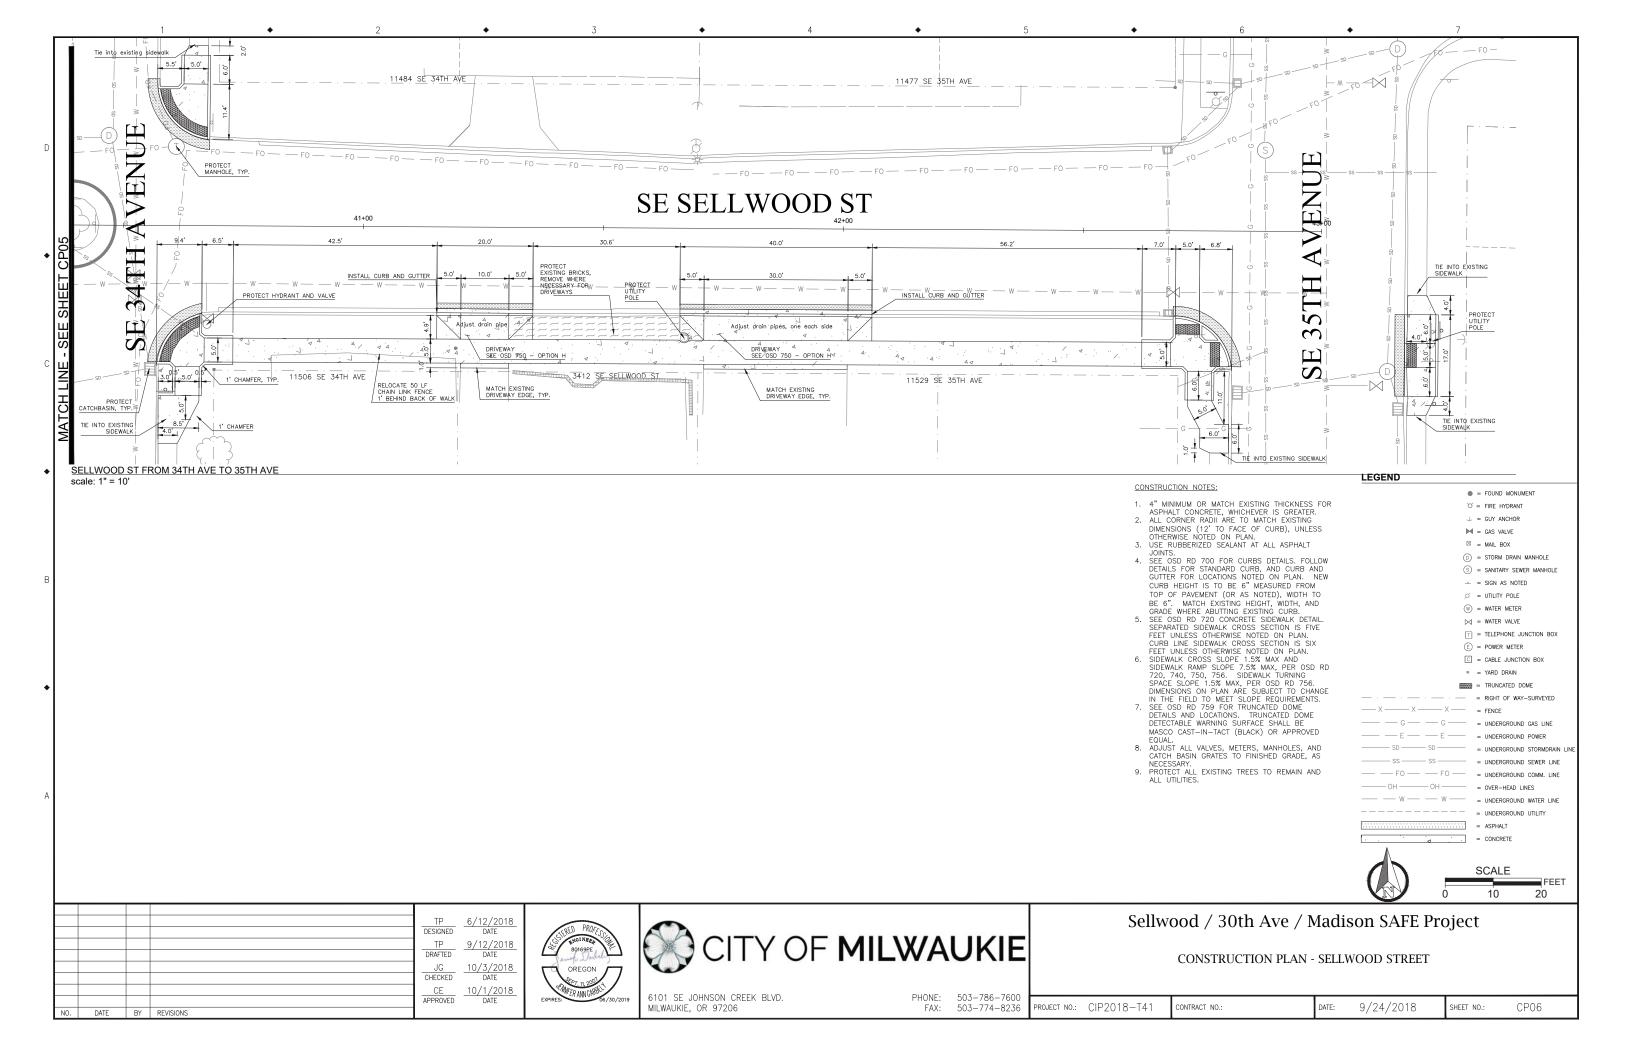

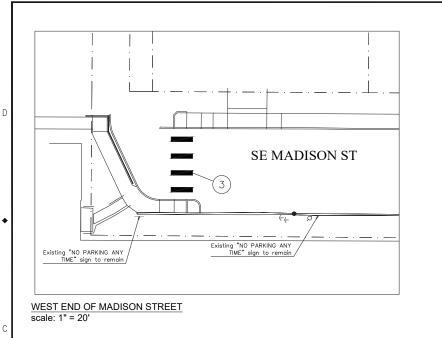


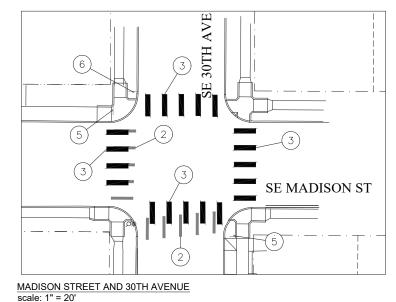





CONSTRUCTION NOTES:

- REMOVE EXISTING STREET SIGN. REPLACE POST PER
 DETAIL OSD TM 681. INSTALL PER THE OREGON
 STANDARD DRAWING (OSD) TM 200 SIGN INSTALLATION
- (2) REMOVE EXISTING STRIPING.
- (3) WHITE THERMOPLASTIC STRIPE (STAGGERED CONTINENTAL CROSSWALK 2' WHITE BARS), PER THE OSD TM 503 PAVEMENT MARKINGS STANDARD DETAIL BLOCKS.
- (4) WHITE THERMOPLASTIC STRIPE (STOP BAR 1' WHITE BAR), PER THE OSD TM 503 PAVEMENT MARKINGS STANDARD DETAIL BLOCKS.
- (5) REMOVE EXISTING SIGN
- (6) REPLACE POST WITH PERFORATED STEEL SQUARE TUBE (PSST) SIGN SUPPORT. SEE DETAIL OSD TM 681.
- (7) RELOCATE EXISTING SIGN. INSTALL PER THE OSD TM 200 SIGN INSTALLATION DETAIL, AS MODIFIED.
- (8) REPLACE POST WITH PERFORATED STEEL SQUARE TUBE (PSST) SIGN SUPPORT. SEE DETAIL OSD TM 681. UPDATE AND REPLACE SIGN PER MUTCD.

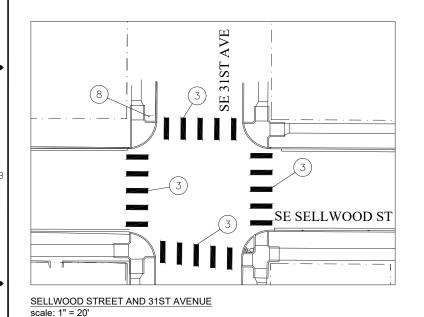

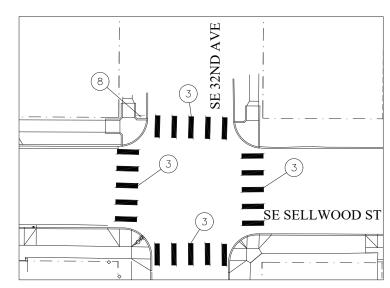



SELLWOOD STREET AND 32ND AVENUE scale: 1" = 20'

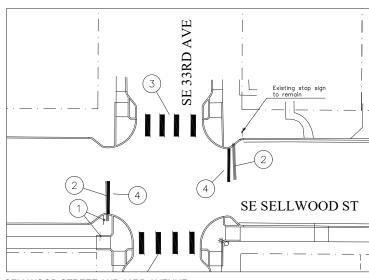

PROJECT NO.: CIP2018-T41

SELLWOOD STREET AND 33RD AVENUE

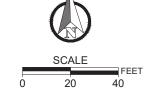

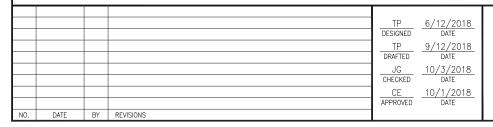





PHONE: 503-786-7600 FAX: 503-774-8236 6101 SE JOHNSON CREEK BLVD. MILWAUKIE, OR 97206

SIGNING AND MARKING PLAN

Sellwood / 30th Ave / Madison SAFE Project

CONTRACT NO.: 9/24/2018


SHEET NO.:

SN01

SE SELLWOOD ST

AVENUE

35TH

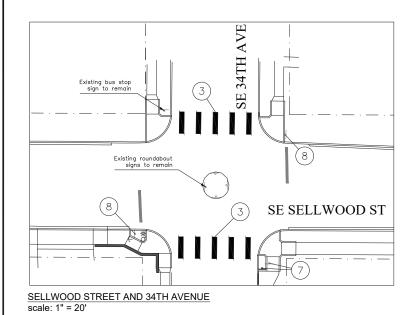



SELLWOOD STREET AND 35TH AVENUE scale: 1" = 20'

SE SELLWOOD ST

CONSTRUCTION NOTES:

- REMOVE EXISTING STREET SIGN. REPLACE POST PER DETAIL OSD TM 681. INSTALL PER THE OREGON STANDARD DRAWING (OSD) TM 200 SIGN INSTALLATION DETAIL, AS MODIFIED.
- 2 REMOVE EXISTING STRIPING.
- (3) WHITE THERMOPLASTIC STRIPE (STAGGERED CONTINENTAL CROSSWALK 2' WHITE BARS), PER THE OSD TM 503 PAVEMENT MARKINGS STANDARD DETAIL BLOCKS.
- (4) WHITE THERMOPLASTIC STRIPE (STOP BAR 1' WHITE BAR),PER THE OSD TM 503 PAVEMENT MARKINGS STANDARD DETAIL BLOCKS.
- (5) REMOVE EXISTING SIGN
- (6) REPLACE POST WITH PERFORATED STEEL SQUARE TUBE (PSST) SIGN SUPPORT. SEE DETAIL OSD TM 681.
- (7) RELOCATE EXISTING SIGN. INSTALL PER THE OSD TM 200 SIGN INSTALLATION DETAIL, AS MODIFIED.
- (8) REPLACE POST WITH PERFORATED STEEL SQUARE TUBE (PSST) SIGN SUPPORT. SEE DETAIL OSD TM 681. UPDATE AND REPLACE SIGN PER MUTCD.

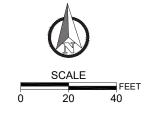

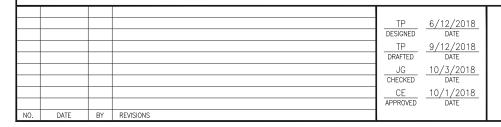



CITY OF MILWAUKIE	=
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6101 SE JOHNSON CREEK BLVD. MILWAUKIE, OR 97206

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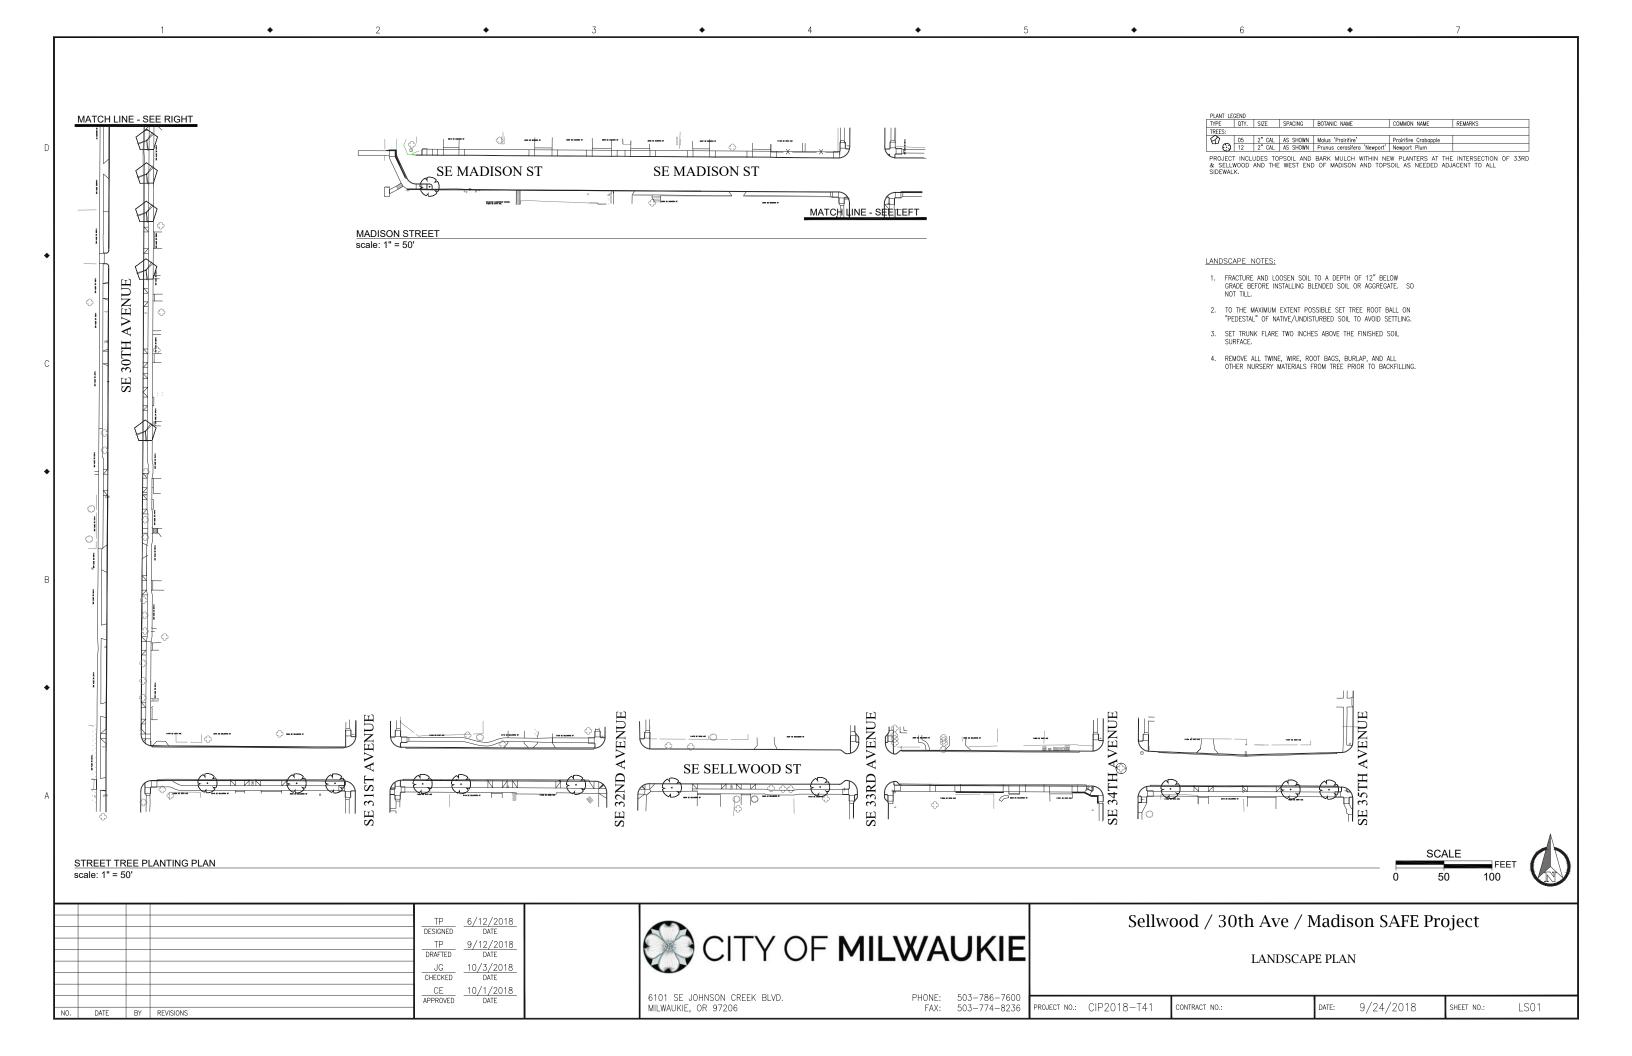
SIGNING AND MARKING PLAN

Sellwood / 30th Ave / Madison SAFE Project

PROJECT NO.: CIP2018-T41 CONTRACT NO.: 9/24/2018

SHEET NO .:

SN02



STANDARD CURB
OSD RD 770

SIDEWALK 4*
OSD RD 770

AGGREGATE BASE 12*

AGGREGATE BASE 12*

AGGREGATE BASE 12*

ATAL PEDESTRIAN HANDRAIL
OSD RD 770

SIDEWALK 4*
OSD RD 780
AGGREGATE BASE 2*

AGGREGATE BASE 2*

2 SE MADISON SEPARETED SIDEWALK
STA: 10+0.45 TO 10+40.09

R/W 60.0'

R/W 60.0'

10.0'

SIDEWALK 4"
6" AT DRIVEWAYS
OSD RD 720
OSD RD 720
AGGREGATE BASE 2"

AGGREGATE BASE 12"
6"
AGGREGATE BASE 12"
6"
AGGREGATE BASE 12"
6"
AGGREGATE BASE 12"
6"
AGGREGATE BASE 12"

② SE MADISON CURB TIGHT SIDEWALK STA: 10+34.07 TO 14+63.15 scale: NTS

scale: NTS


R/W 60.0'

R/W 60.0'

SIDEWALK 4"
6" AT DRIVEWAYS
OSD R0 720

AGGREGATE BASE 2"

① SE 30TH SEPARATED SIDEWALK
STA: 21+17.34 TO 24+84.30, 24+94.29 TO 25+36.54, 25+66.57 TO 26+20.91, 26+64.51 TO 27+65.80 scale: NTS

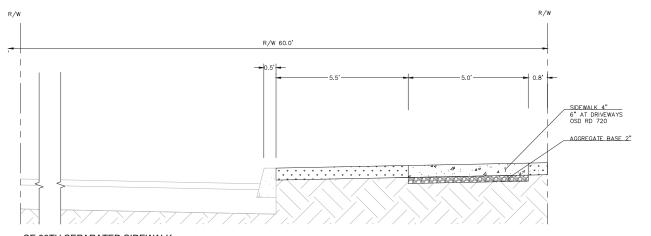

2 SE 30TH SEPARATED SIDEWALK STA: 25+36.54 TO 25+66.57, 26+20.91 TO 26+64.51 scale: NTS

| TP | 6/12/2018 | DESIGNED | DATE | TP | 9/12/2018 | DATE | TP | 9/12/2018 | DATE | TP | DATE | DAT





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Sellwood / 30th Ave / Madison SAFE Project


TYPICAL SECTIONS - MADISON STREET & 30TH AVENUE


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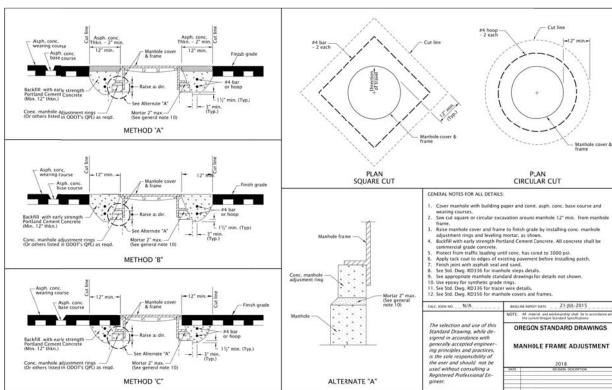
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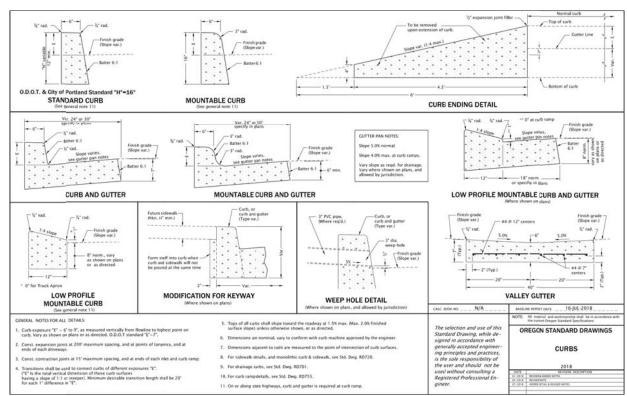
9/24/2018 SHEET NO.:

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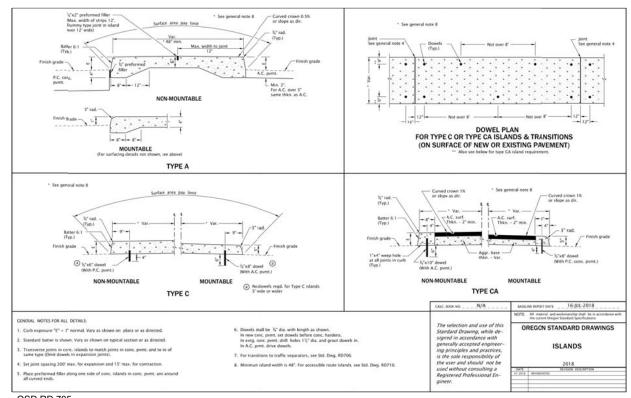







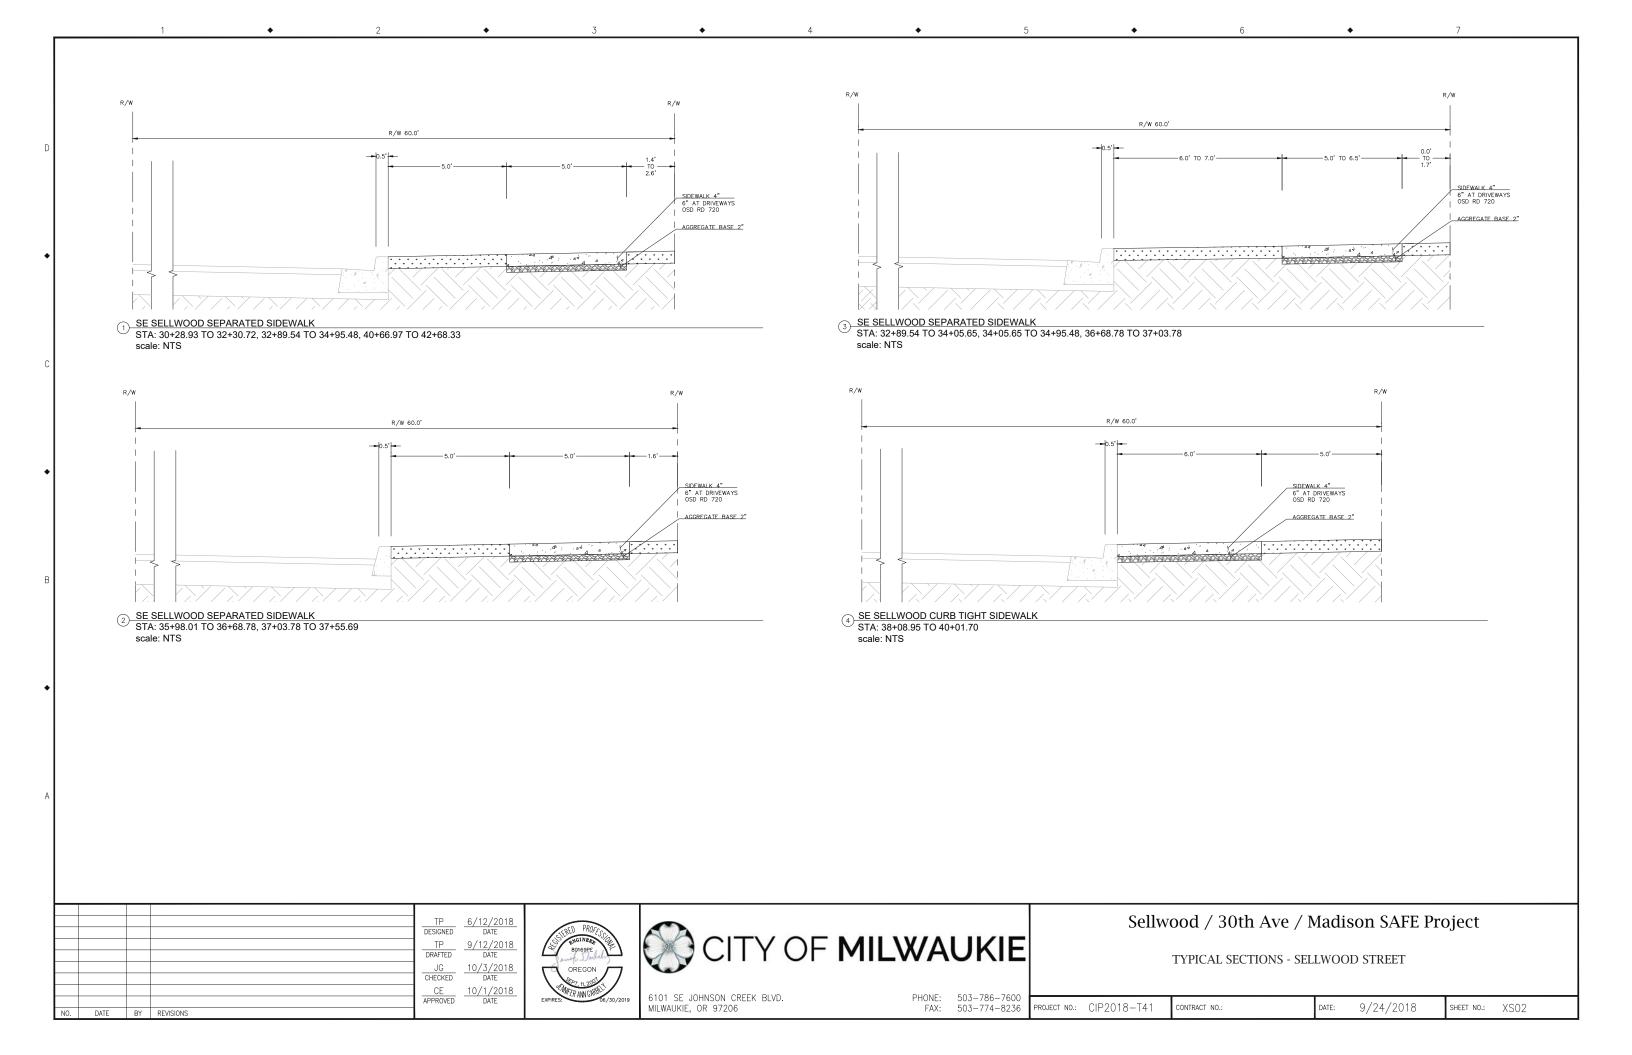

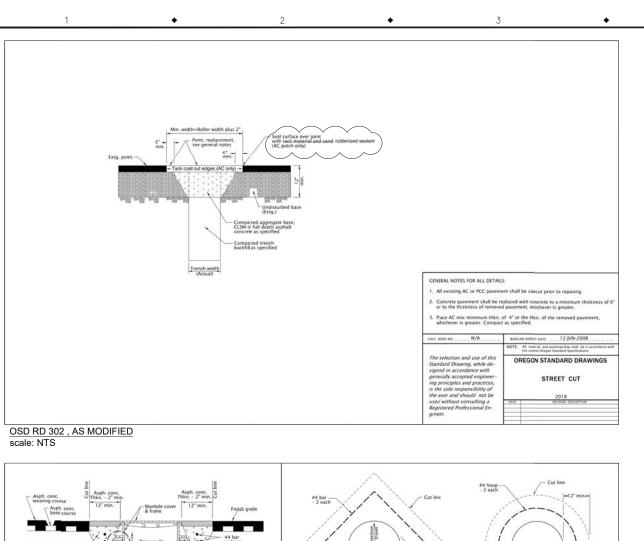OSD RD 700 scale: NTS



OSD RD 705 scale: NTS

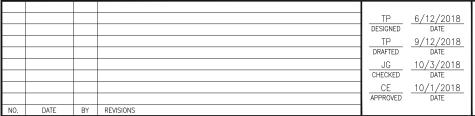

OSD RD 360

scale: NTS





CONSTRUCTION DETAILS

Sellwood / 30th Ave / Madison SAFE Project


PHONE: 503-786-7600 FAX: 503-774-8236 6101 SE JOHNSON CREEK BLVD. MILWAUKIE, OR 97206


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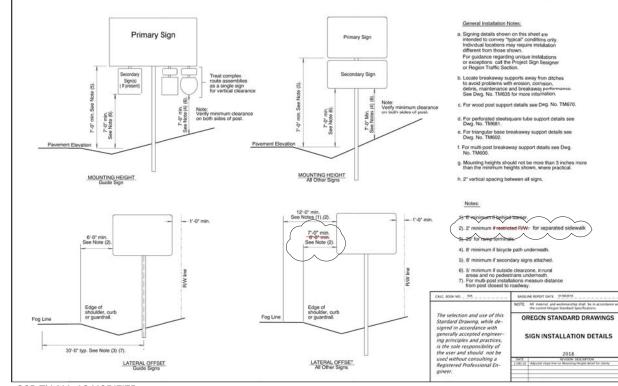
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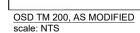
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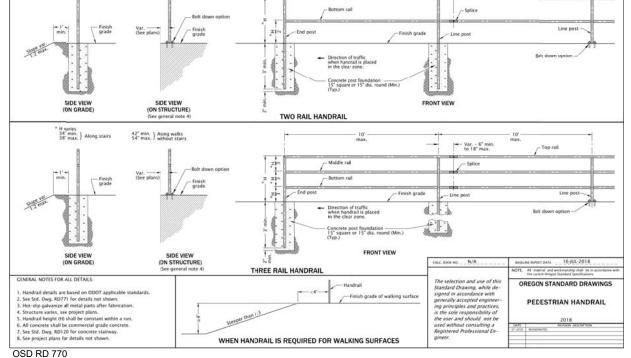
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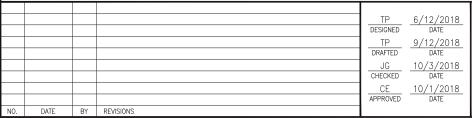








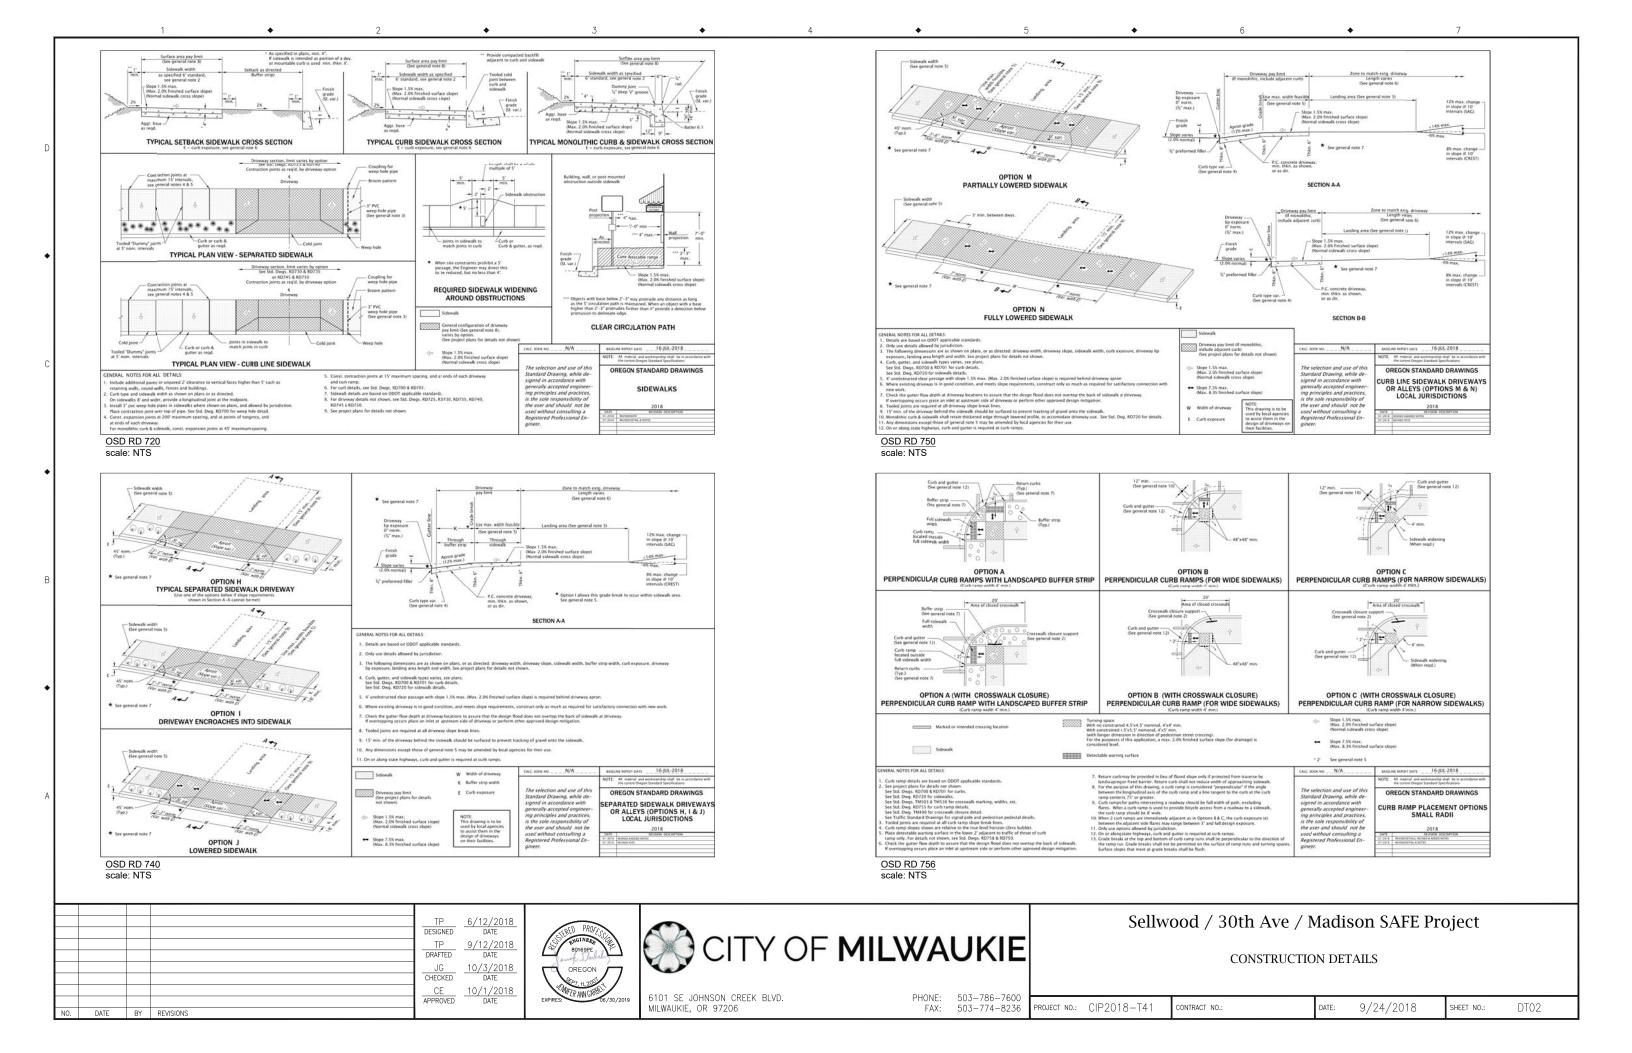

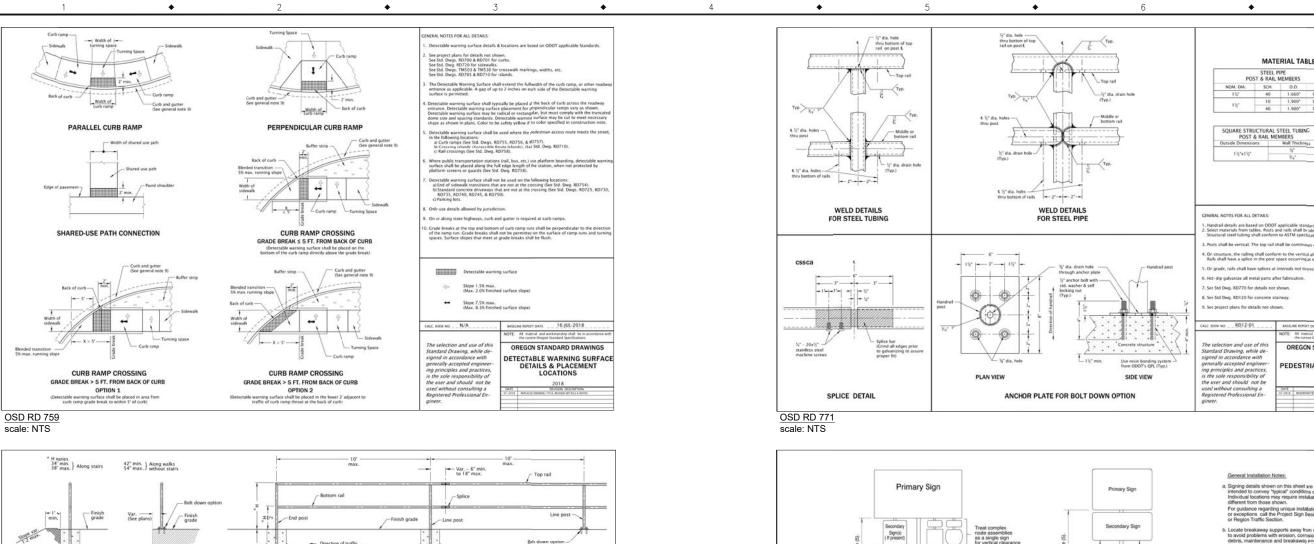

scale: NTS





6101 SE JOHNSON CREEK BLVD. PHONE: 503-786-7600 MILWAUKIE, OR 97206 FAX: 503-774-8236 Sellwood / 30th Ave / Madison SAFE Project CONSTRUCTION DETAILS


MATERIAL TABLES

SQUARE SPLICE BAR

PEDESTRIAN HANDRAIL DETAILS

DT03

PROJECT NO.: CIP2018-T41 DATE: 9/24/2018 SHEET NO .:

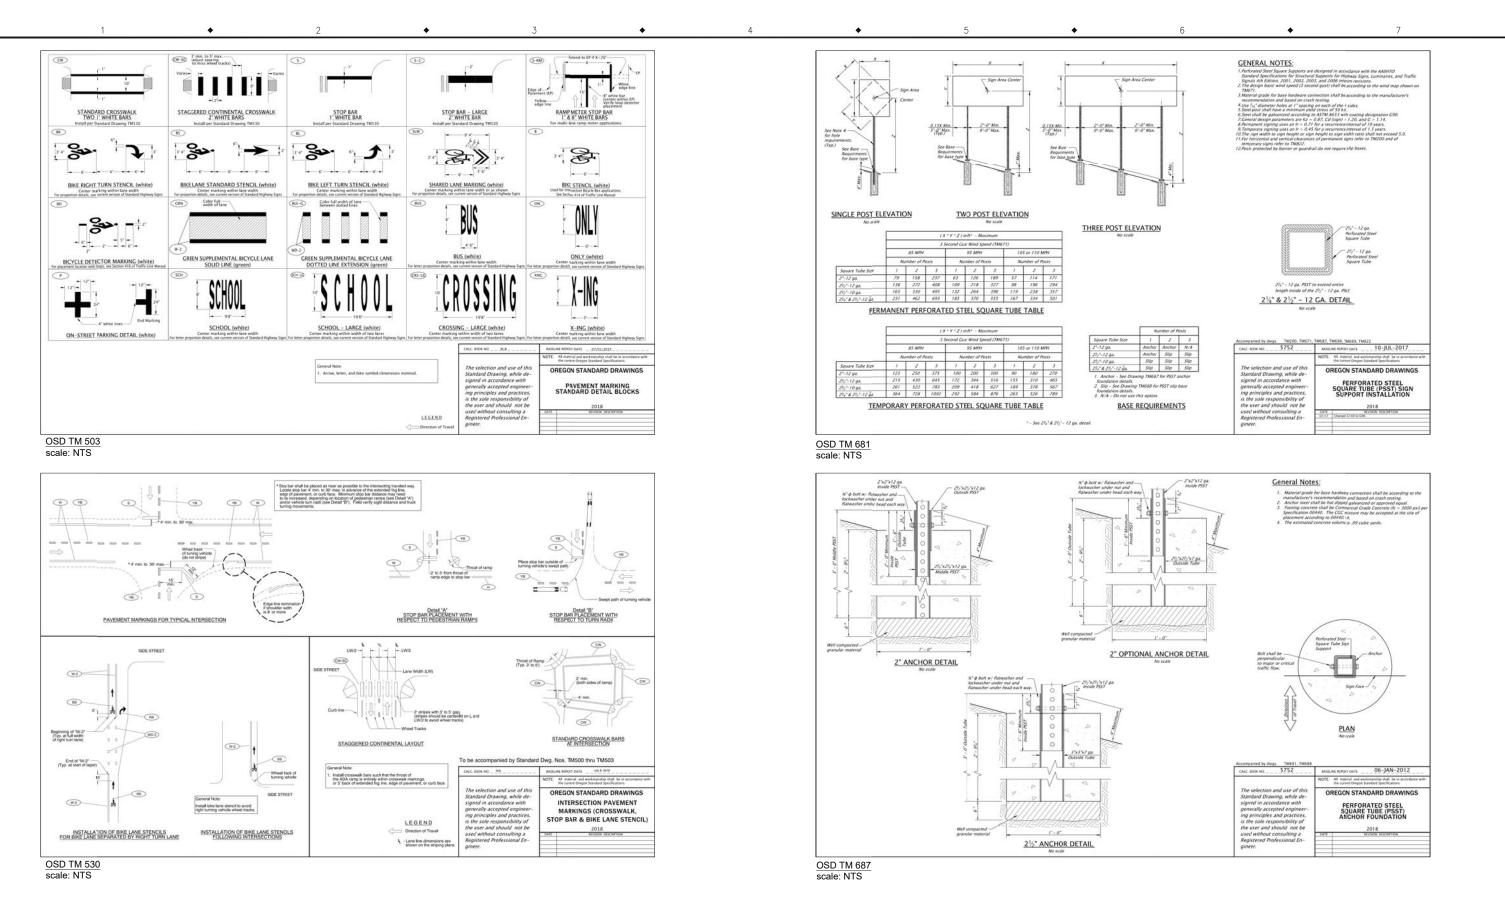



CITY OF MILWAUKIE


CONSTRUCTION DETAILS


Sellwood / 30th Ave / Madison SAFE Project


DT04

6101 SE JOHNSON CREEK BLVD.
MILWAUKIE, OR 97206

PHONE: 503-786-7600
FAX: 503-774-8236
PROJECT NO.: CIP2018-T41
CONTRACT NO.: DATE: 9/24/2018 SHEET NO.:

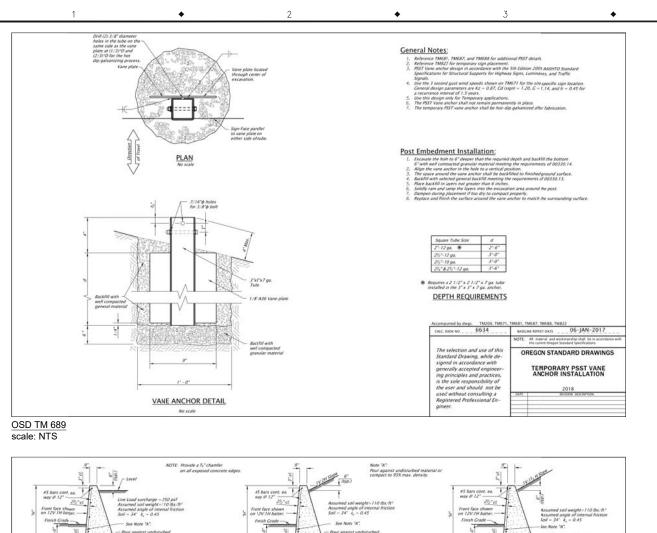


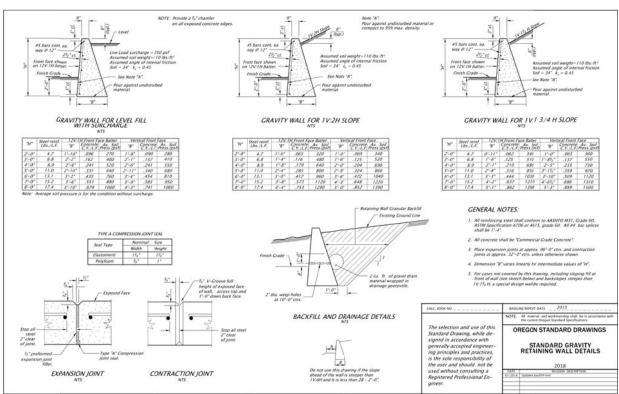

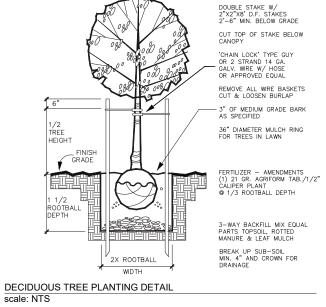

PLANT ALL TREES W/ TOP OF ROOTBALL 1" ABOVE FINISH GRADE

DECIDUOUS TREE PLANTING DETAIL

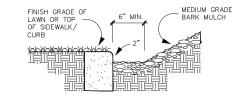

BARK CATCH DETAIL

scale: NTS

Sellwood / 30th Ave / Madison SAFE Project

CONSTRUCTION DETAILS

6101 SE JOHNSON CREEK BLVD. MILWAUKIE, OR 97206 PHONE: 503-786-7600 FAX: 503-774-8236

PROJECT NO.: CIP2018-T41

CONTRACT NO.: DATE:

9/24/2018

SHEET NO .: DT05

NO. DATE BY REVISIONS

OSD BR 720 scale: NTS

> 6/12/2018 DATE DESIGNED TP 10/3/2018 DATE CHECKED CE APPROVED 10/1/2018 DATE

CITY OF MILWAUKIE